
Appendix A: Site Location Plan

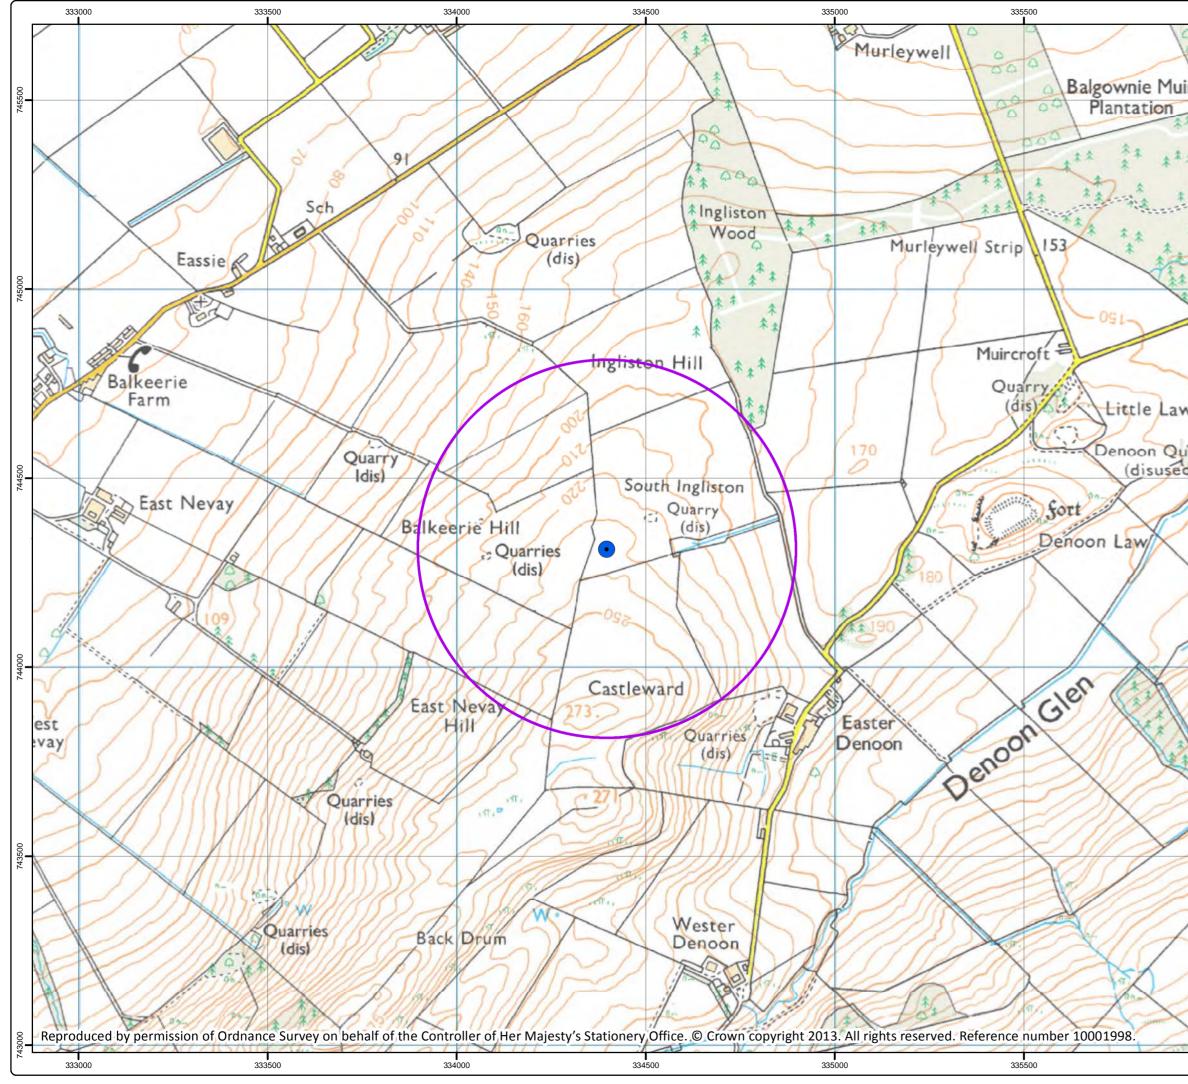

745500		urvey Area urbine Location			
-2					
745000					
1 744500					
	Do not scale this map Client)			
		Locogen			
744000	Project	gliston Hill Sin	gle Tu	urbine	
	Title	Site Location	Plan		
	Status	FINAL			
743500	Drawing No. 164621 - 001				Revision
	Scale 1:10,000		A3	Date 10 Sept	2013
	Drawn FR	Checked XX		Approved FR	-
743000	ENV		Э	Craighall Bu Park, Eagle S Glasgow, G4 Tel: 0141 34 Fax: 0141 34	Street, 9XA 1 5040

Appendix B: Site Photographs



Photograph 1: A view of the proposed turbine location.



Photograph 2: A view of the deer fence along the east site boundary.



Photograph 3: A breach in the deer fence along the east site boundary.



Photograph 4: A view of the improved grassland habitat that dominates the site.



Photograph 5: A view of the tall ruderal vegetation along the filed boundary in the east.



Photograph 6: A view of the scattered sycamore trees in the east of the site.




Photograph 7: A view of the rubble pile associated with the former quarry to the east of the proposed turbine location.



Photograph 8: A view of the scattered gorse scrub.




Photograph 9: A view of one of the many rabbit holes present within the site.

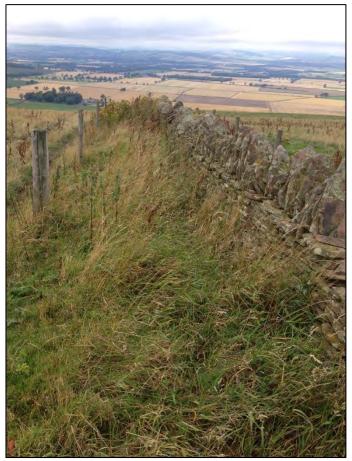

Photograph 9: A view of the stone wall along a field boundary in the west of the site.

Appendix C: Phase 1 Habitat Map

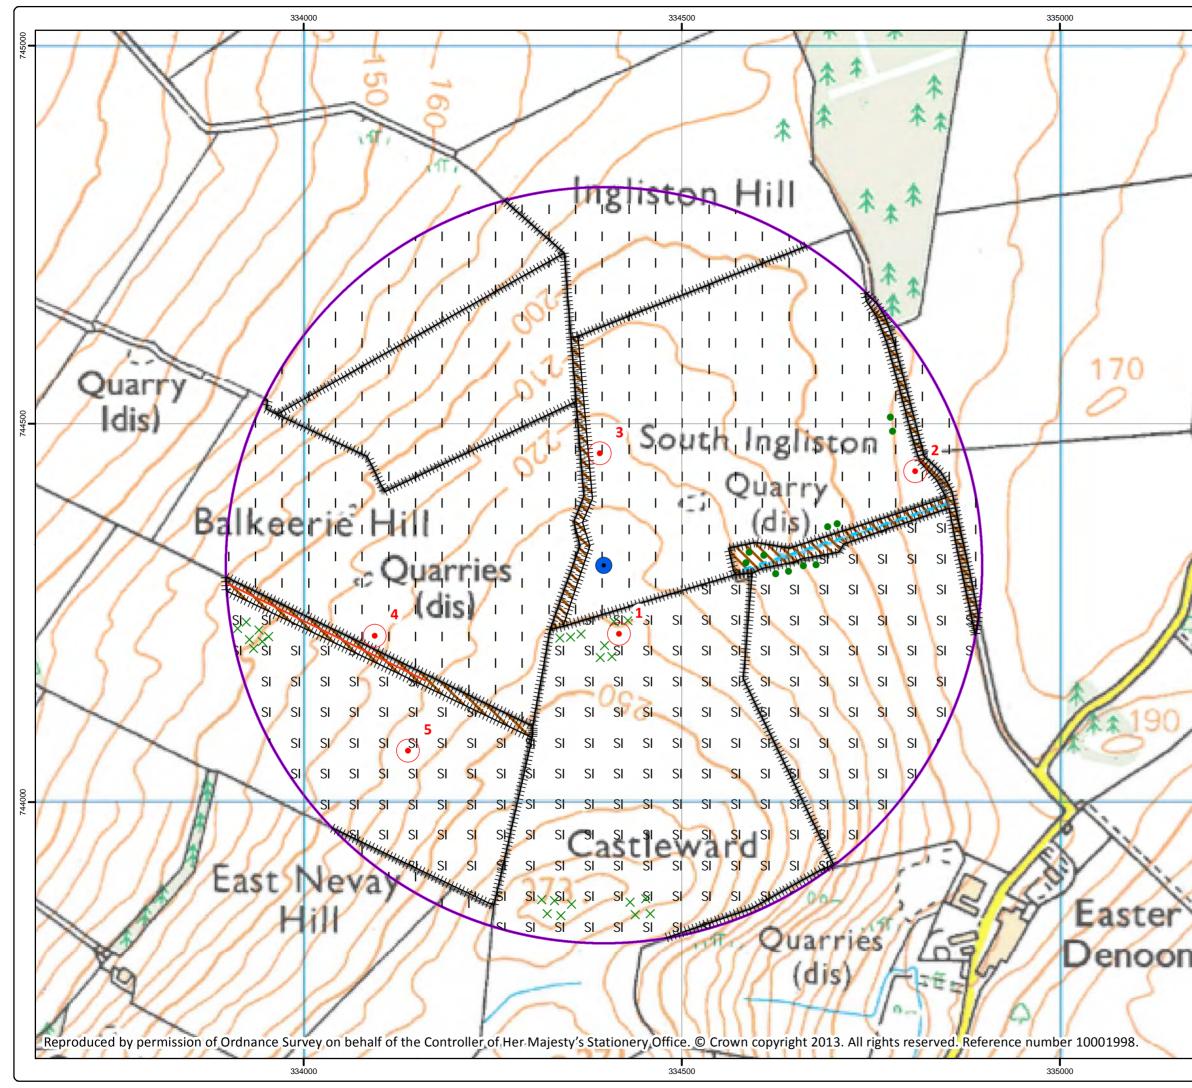

745000	Legend							
	•	Target Note						
	Turbine Location							
		Survey Area						
	JNCC Code							
	× ×	A2.2 - Scattered	Scrub					
		A3.1 - Scattered	Broadl	lea	aved Tree	s		
		B4 - Improved G	rasslan	nd				
		B6 -Semi-Improv	/ed Gra	ass	sland			
		C3.1 - Tall Ruder	al					
		J2.4 - Post & Wir	re Fenc	e				
		J2.5 - Wall						
744500		J2.6 - Dry Ditch						
744								
1	Do not scale this m	ap						
1	Client	- F						
		Locoger	1					
-	Project							
		Ingliston Hill Si	ngle Tu	url	bine			
	Title							
		Phase 1 Habi	tat Sui	rv	ey			
8								
744000	Status	FINAL						
	Drawing No.	FINAL	-			Revision		
	164621 - 00	01						
	Scale		A3		Date			
	1:5,000 Drawn	Checked	AJ		10 Sept	2013		
1	FR	ХХ			Approved FR			
	EN		е	Pa Gl Te	raighall Bus ark, Eagle S lasgow, G4 el: 0141 34 ax: 0141 34	street, 9XA 1 5040		

Appendix D: Target Notes

Date of Survey: 30th August 2013 **Recorder Name:** Karen Hassard **Weather Conditions:** Bright and clear with an air temperature of 17°C.

Target Note Details 1. Feature: Scattered scrub Description: This habitat is present to the south of the proposed turbine location. Although it is not continuous it may provide a suitable commuting and foraging route for gap tolerant bat species such as pipistrelles. 2. Feature: Post and wire fencing Description: A deer fence is present along the east site boundary adjacent to the coniferous woodland. A breach was discovered in the bottom of the fence but no evidence of badger was identified. 3. Feature: Tall ruderal **Description:** tall ruderal vegetation was present along the field boundary to the west of the proposed turbine location. The longer vegetation may provide suitable cover and shelter for commuting mammals. 4. Feature: Wall **Description:** A stone wall is present along the field boundary in the south west of the site. It may provide suitable shelter for reptiles and amphibians. 5. Feature: Rabbit warrens Description: Rabbit holes were recorded in the field to the south west of the turbine. These looked similar to badger holes from the outside but were identified to split into smaller holes just inside the entrance. These tunnels were considered too small for badger. No badger field signs were identified.



Appendix C – Manufacturer's Noise Data and ReSoft Windfarm Report Exports

	Model	Attenuation T	urbine Noise In	formation	
 Use Spe Turbine 	cify turbine file name (a from layout (c data file (single first turbine if us	turbine for all lo ing the layout) :	cations)	1
) Use	e reference he layout co	eight to be used wind speed ontains different wind speed 1	10.00 - m/ turbines only c	s at 10.00m ommon reference speeds will be show	n.
	🔘 Use exp	lowing wind pro ponent Ighness length	0.16	The wind profile is used to calculate the wind speed at the reference hei from the specified speed and height	ght
	🔘 Use exp	ponent ughness length	0.16 0.05	the wind speed at the reference hei	ght

alculation	Model	Attenuation	n Turbine	Noise Information		
Noise M	odel					
🔘 Da	nish noise	e standard				
ISC ISC	9613					
Noise sp	reading n	nodel				
				on coefficient is u at 0.002 is used fo		dband spreading. n model.
Only th	e alterna	te ISO 9613	ground ma	del can be used w	ith broadbar	nd spreading.
result v a defa	vill be 3d ult in the	B lower than ISO 9613 mc	the Danish odel.	dband spreading a model because h nd attenuation :		nd attenuation the s not included as dB(A) / m
1.2.1.5		10.000			0.000	
_				n is specified on th	ie allenuali	on page)
Use Use	line of si	gnt distance	(includes t	rbine hub height)		
Additiona	al Factors					
Add	a base le	evel noise of	0	dB(A)		
Use Use	a distano	ce limit of	5000	metres (noise ig	nored beyor	nd this distance)

Calculation	Model	Attenuation	Turbine Noi:	se Informatio	n		
O Us	e default a ecify atter	nuation manua	r Danish mode		nperature)		
Hu	umidity (%)	: 70%	▼ Ter	mperature (d	leg C) :	10 🔻]
		At	tenuation Coe	fficents (dE	3/m)		
Hz 6			500 4 0.00193	1000 0.00366	2000 0.00966	4000 0.0328	8000 0.117
🕅 Ke	eep attenu	uation as defa	ult	Reset	attenuati	on to original	defaults
Ground	Attenuatio ground a)anish = hard	ground, 3d	B more th	an with ISO	9613)
@ ISC) 9613 emative IS	SO 9613					
í⊚ ISC ⊘ Alte	0 9613 emative IS	50 9613 =hard, 1=soft)					
ISC Alter Porosity	0 9613 emative IS	=hard, 1=soft)	<u> </u>	dle : 0.5		Receiver :	0.5

Calculation M	lodel Atte	nuation	Furbine N	oise Inform	nation	n		
This turbine	data is just	for informa	tion. Use	the Turbin	ne Sti	udio to ch	ange any	values.
Turbine File	: C:\DRO	PBOX\WIN	IDFARMF	R4\WTDB	\EW	T - Direct	wind\EW [*]	г
Turbine broa	adband sou	and power l	evel :	99.5	dB(A)		
Reference r	Reference measurement windspeed :			10	m/s	at heigh	t: 10	m
Reference r	neasureme	nt roughne:	SS :	0.05	m			
Variation of	noise with	wind speed	:	0.8	dB(A) / m/s		
Tonal penal	ty :			0	dB(A)		
Octave data	a - dB(A)							
Hz 63	125	250	500	1000		2000	4000	8000
80.75	86.95	92.25	93.55	92.15	5	89.65	82.75	70.95
				0	ĸ		Cancel	Help

	INGLISTON FARM INGLISTON FARM.WFL
Revised Revision Title Author	NINGLISTON.WFN 14:23:37 28-Aug-2013 09:37:44 18-Sep-2013 47
Turbine noise data Turbine file (first)	From the layout \WTDB\EWT - Directwind\EWT Directwind - Measured 500kW ocata
NOISE MODEL Noise standard Noise spreading model Use line-of-sight distance	Octaves
Temperature Attenuation coefficients	: 70 % : 10 deg C
125 Hz 250 Hz 500 Hz 1000 Hz 2000 Hz 4000 Hz	<pre>0.00012 0.00041 0.00104 0.00193 0.00366 0.00966 0.03280 0.11700</pre>
GROUND ATTENUATION Formulation Source porosity Middle porosity Receiver porosity	: ISO 9613 : 0.50 : 0.50
Wind speed Wind speed height	NO 10.00 10.0 0.0500
	None None
House ID Easting I 1 334985 2 333417 3 333268 4 333343 5 333409 6 334866 7 333528	NorthingAltitudeNoise (db)743907029.75744287026.44744163024.83744934024.05745008024.18743812030.17745106024.47



Emergya Wind Technologies BV

DW54

Category:	Specification	Page 1/11
Doc code:	S-1005030	

Created by:	RH	Creation Date:	09-05-12
Checked by:	LE	Checked Date:	09-05-12
Approved by:	ТҮ	Approved Date:	09-05-12

Title:

Specification

Sound power level DW54 - 500kW

Revision	Date	Author	Approved	Description of changes
01	17-08-12	RH	ТҮ	corrected format
-	-	-	-	-
-	-	-	-	-
-	-	-	-	-
-	-	-	-	-
-	-	-	-	-

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b	Category:	Specification	Revision: 01
()-)FWT	Title:	Sound power level DW54 - 500kW	Page 2/11
	Doc code:	S-1005030	

Contents

1	Introduction	3
2	Measurements	4
3	Results	5
3.1	Corrected sound power level graphical	
3.2	Tonal Audibility	
3.3	Uncertainty	9
Аррен	ndix 1 Third octave band sound power levels	10
Аррен	ndix 2 measured sound pressure levels	11

b	Category:	Specification	Revision: 01
()-)FWT	Title:	Sound power level DW54 - 500kW	Page 3/11
	Doc code:	S-1005030	

1 Introduction

Following information with regard to the sound power level measurements, are distillated from measurement data of a *DIRECTWIND* 54 500kW turbine, located at the Elbaweg in Venhuizen, the Netherlands.

The measurements were performed by a third party according to the International Standard IEC 64100-11 December 2002: "Wind turbine generator systems – Part 11: Acoustic noise measurement techniques ".

b	Category:	Specification	Revision: 01
()-)FWT	Title:	Sound power level DW54 - 500kW	Page 4/11
	Doc code:	S-1005030	

2 Measurements

The measurements have been performed by measuring the sound pressure levels in the third octave bands of 25 Hz to 10,000 Hz at the reference point downwind of the operating turbine. The background noise level was measured during standstill of the turbine.

Measurements were carried out on the ground on a hard board according to the IEC standard. This method doubles the pressure on the microphone which raises the sound pressure level with +6 dB(A) compared to free field measurements.

The measured sound pressure levels can be found in Appendix 2 measured sound pressure levels.

b	Category:	Specification	Revision: 01
()-)FWT	Title:	Sound power level DW54 - 500kW	Page 5/11
	Doc code:	S-1005030	

3 Results

The sound power levels are calculated from the measured sound pressure levels according to IEC-61400-11. The wind velocities have been corrected for a reference roughness Z_0 of 0.05m by applying a factor of 1.1 on the measured wind velocity, and the sound power levels have been calculated for a reference height of 10m.

Sound power level	middle frequency of the octave bands [hz]									
Wind speed at a height of 10m		31.5	63	125	250	500	1k	2k	4k	8k
Wind 5 m/s	95.0 dB(A)	67.3	76.3	82.5	89.0	90.3	87.9	85.3	80.6	71.0
Wind 6 m/s	96.6 dB(A)	68.2	78.0	84.1	90.7	92.0	89.5	86.7	81.4	72.4
Wind 7 m/s	97.7 dB(A)	69.5	79.3	85.5	91.8	93.0	90.7	88.0	82.2	72.9
Wind 8 m/s	98.8 dB(A)	70.9	80.7	86.9	92.6	94.1	92.0	89.2	83.0	72.8
Wind 9 m/s	99.7 dB(A)	72.4	82.1	88.3	93.5	94.7	92.9	90.3	83.5	72.0
Wind 10 m/s	99.5 dB(A)	72.2	81.6	87.8	93.1	94.4	93.0	90.5	83.6	71.8

Table 3.1 gives the calculated sound power levels at the different wind speeds, and the calculated octave band power levels. Figure 3.1 gives the calculated 3rd octave band sound power levels, the values for these can be found in Appendix 1 Third octave band sound power levels.

Sound power level	middle frequency of the octave bands [hz]									
Wind speed at a height of 10m		31.5	63	125	250	500	1k	2k	4k	8k
Wind 5 m/s	95.0 dB(A)	67.3	76.3	82.5	89.0	90.3	87.9	85.3	80.6	71.0
Wind 6 m/s	96.6 dB(A)	68.2	78.0	84.1	90.7	92.0	89.5	86.7	81.4	72.4
Wind 7 m/s	97.7 dB(A)	69.5	79.3	85.5	91.8	93.0	90.7	88.0	82.2	72.9
Wind 8 m/s	98.8 dB(A)	70.9	80.7	86.9	92.6	94.1	92.0	89.2	83.0	72.8
Wind 9 m/s	99.7 dB(A)	72.4	82.1	88.3	93.5	94.7	92.9	90.3	83.5	72.0
Wind 10 m/s	99.5 dB(A)	72.2	81.6	87.8	93.1	94.4	93.0	90.5	83.6	71.8

Table 3.1 Sound power levels and the octave band data

h	Category:	Specification	Revision: 01
()-)FWT	Title:	Sound power level DW54 - 500kW	Page 6/11
	Doc code:	S-1005030	

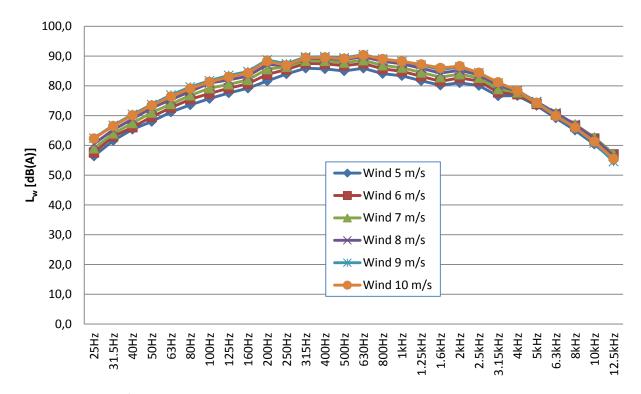


Figure 3.1 The 3rd octave band Sound Power Level spectra

h	Category:	Specification	Revision: 01
()-)FWT	Title:	Sound power level DW54 - 500kW	Page 7/11
	Doc code:	S-1005030	

3.1 Corrected sound power level graphical

Figure 3.2 and table 3.2 below provides all the calculated sound power levels at the different wind speeds at reference conditions (h = 10 m and $z_0 = 0.05 \text{ m}$) and after correction for the background noise. The figure also gives the 4th order regression on this curve:

$$L_W = 0.0033V_{wind}^4 - 0.1327V_{wind}^3 + 1.7261V_{wind}^2 - 7.8733V_{wind} + 106.02 \, dB(A)$$

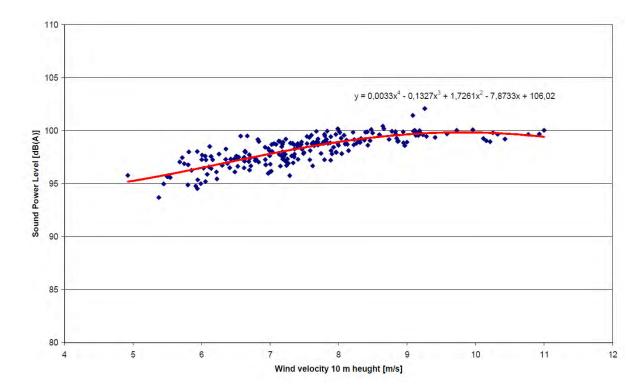


Figure 3.2 the calculated sound power level at different wind speeds

Sound power level with 4 th Order regression in dB(A) Wind speed at a height of 10m				
Wind 5 m/s	95.3 dB(A)			
Wind 6 m/s	96.5 dB(A)			
Wind 7 m/s	97.8 dB(A)			
Wind 8 m/s	98.9 dB(A)			
Wind 9 m/s	99.6 dB(A)			
Wind 10 m/s	99.8 dB(A)			

Table 3.2 Sound Power Levels with 4th Order regression

b	Category:	Specification	Revision: 01
()-)FWT	Title:	Sound power level DW54 - 500kW	Page 8/11
	Doc code:	S-1005030	

3.2 Tonal Audibility

The audibility of the tones in the sound was analysed at the reference position and is given in Table 3.3 Tonal Audibility. The most important frequencies are 2.2 and 4.4 kHz. In Table 3.3 also the tonal penalty according to ETSU-R-97 (The assessment and rating of noise from wind farms – September 2006) is given. For the tone level of 3.3, the ETSU penalty of 2.5 dB can be found in Figure 3.3. No penalties are incurred for audibility levels below 2.0 dB.

According to ETSU-R-97, the tonal penalty should be added at the receiver for the specific wind speed at which the tonal audibility is present.

Wind @ 10 m ([m/s]	5	6	7	8	9
ΔL _A [dB(A)]	3.3	0.9	1.5	0.7	-0.7
ETSU Penalty [dB]	2.5	-	-	-	-

Table 3.3 Tonal Audibility

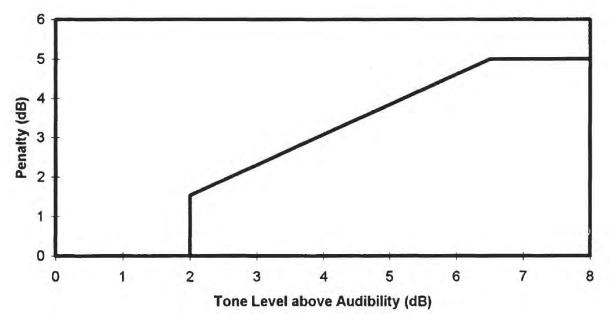


Figure 3.3 Tonal penalty according to ETSU-R-97

b	Category:	Specification	Revision: 01
()-)FWT	Title:	Sound power level DW54 - 500kW	Page 9/11
	Doc code:	S-1005030	

3.3 Uncertainty

The following Table 3.4 gives the number of measurements and the uncertainty in dB(A) for each different wind speed.

Wind Class	Number of measurements	Uncertainty [dB(A)]
Wind 5 m/s	4	1.7
Wind 6 m/s	37	1.4
Wind 7 m/s	77	1.2
Wind 8 m/s	68	0.9
Wind 9 m/s	26	0.9
Wind 10 m/s	9	0.7

Table 3.4 Number of measurements and uncertainty

b	
	ŀ

Doc code: S-1005030

Title:

Appendix 1 Third octave band sound power levels

Sound power level DW54 - 500kW

V10[m/s]	25Hz	31.5Hz	40Hz	50Hz	63Hz	80Hz	100Hz	125Hz	160Hz
Wind 5 m/s	56,4	61,6	65,4	68,0	71,2	73,6	75,7	77,6	79,2
Wind 6 m/s	57,6	63,0	66,1	69,6	72,7	75,5	77,4	79,2	80,7
Wind 7 m/s	59,0	64,0	67,5	71,0	73,9	76,8	79,2	80,5	82,0
Wind 8 m/s	60,5	65,2	68,9	72,6	75,3	78,1	80,9	82,0	83,3
Wind 9 m/s	62,4	66,7	70,4	73,7	76,9	79,6	81,7	83 <i>,</i> 5	84,8
Wind 10 m/s	62,3	66,5	70,1	73,4	76,4	79,1	81,3	83,0	84,3

V10[m/s]	200Hz	250Hz	315Hz	400Hz	500Hz	630Hz	800Hz	1kHz	1.25kHz
Wind 5 m/s	81,6	84,0	85,9	85,7	85,0	85,9	84,1	83,4	81,7
Wind 6 m/s	83,8	85,5	87,5	87,4	86,8	87,5	85,7	84,9	83,2
Wind 7 m/s	85,6	86,4	88,4	88,4	87,8	88,6	86,9	86,1	84,5
Wind 8 m/s	87,1	86,9	89,2	89,2	88,8	89,8	88,2	87,4	85,9
Wind 9 m/s	88,7	87,4	89,7	89,8	89,4	90,5	89,0	88,2	87,0
Wind 10 m/s	88,3	86,9	89,4	89,5	89,1	90,3	89,0	88,2	87,2

V10[m/s]	1.6kHz	2kHz	2.5kHz	3.15kHz	4kHz	5kHz	6.3kHz	8kHz	10kHz	12.5kHz
Wind 5 m/s	80,2	81,0	80,1	76,6	76,7	73,4	69,2	65,1	60,4	55,0
Wind 6 m/s	81,5	82,7	81,6	77,8	77,2	73,9	70,4	66,6	62,3	57,0
Wind 7 m/s	82,9	83,9	82,7	78,9	77,8	74,3	70,9	67,1	62,7	57,2
Wind 8 m/s	84,3	85,2	83,7	80,1	78,3	74,7	70,9	67,0	62,4	56,5
Wind 9 m/s	85,5	86,3	84,4	80,9	78,5	74,5	70,2	66,1	60,8	54,6
Wind 10 m/s	86,0	86,6	84,4	81,2	78,4	74,3	69,9	66,0	61,3	55,5

Emt	Category:	Specification	Revision: 01
	Title:	Sound power level DW54 - 500kW	Page 11 / 11
	Doc code:	S-1005030	

Appendix 2 measured sound pressure levels

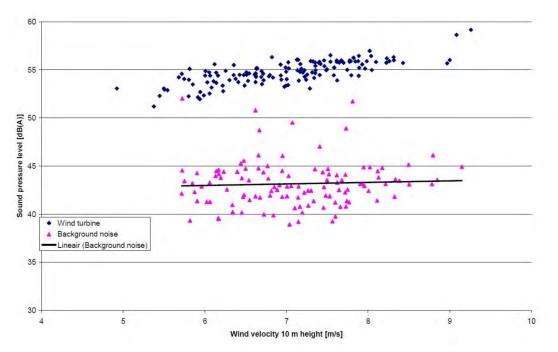


Figure 0.1 Measured sound pressure levels 11 November 2011

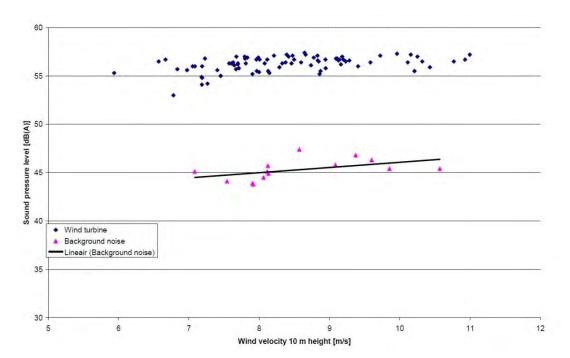


Figure 0.2 Measured sound pressure levels 15 February 2012



Emergya Wind Technologies BV

Engineering

Category:	Specification	Page 1/2
Doc code:	S-1005020	

Created by:	ТҮ	Creation Date:	07-12-11
Checked by:	MS	Checked Date:	07-12-11
Approved by:	ТҮ	Approved Date:	07-12-11

Title:

Specification

Sound power warranty levels DW52/54 500kW

Revision	Date	Author	Approved	Description of changes
02	14-03-12	AB	ТҮ	Modifications based on new IEC measurements
01	09-12-11	AB	ТҮ	correction
-	-	-	-	-
-	-	-	-	-
-	-	-	-	-
-	-	-	-	-

Emergya Wind Technologies BV

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Emt	Category:	Specification	Revision: 02
	Title:	Sound power warranty levels DW52/54 500kW	Page 2/2
	Doc code:	S-1005020	

Sound power levels

The warranted sound power levels are presented with reference to IEC 61400-11:2002.

V _{wind} at 10m height	DW52	DW54
5 m/s	96,5 dB(A)	97.0 dB(A)
6 m/s	97.5 dB(A)	98.0 dB(A)
7 m/s	98.5 dB(A)	99.0 dB(A)
8 m/s	99.5 dB(A)	100.0 dB(A)
9 m/s	100.3 dB(A)	100.5 dB(A)
10 m/s	100.5 dB(A)	100.5 dB(A)

Sound power level Lw in dB(A)

The warranted sound power levels are based on actual measurements executed by an independent noise measurement institute according to the preferred methods set out in IEC-61400-11.

Uncertainty levels are included in the warranted sound power levels.

At 5m/s a maximum tonal noise penalty of 2,5dB shall be considered according to ETSU-R-97 guidelines.

The measured third octave sound power levels are available upon request.

The values given in the table are valid for normal operational mode (rotation speed 0-24 RPM)

The calculation of the standardized wind speed at 10m height according to IEC 61400-11 is based on a terrain roughness length $Z_0=0,05m$.

In case validation measurements have to be performed, they should be executed according to the preferred methods set out in IEC-61400-11 by an independent measurement institute which is accredited to ISO/IEC 17025 to conduct measurements of wind turbine noise emissions.

EWT reserves the right to make modifications or adjust settings in order to comply with the warranted sound power levels.



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Locogen Ltd, 44 Constitution St, Edinburgh, EH6 6RS Tel: +44 (0) 131 555 4745; Email: info@locogen.com Company Number: SC370060; VAT Number: 983 3836 77

Project Description

nber of Turbine(s):	1
bine Model:	EWT Directwind 54
Height:	50m
de diameter:	54m
al height to blade tip:	77m
bine location:	334397 744313

Notes


This map shows the proposed turbine location in black and the boundary of land ownership in blue.

Legend .

Turbine Location

Boundary of Land Ownership

ROJECT:	Ingliston Farm						
AWING TITLE:		Location Plan					
AWING NO:		ING001					
CUMENT SIZE:		A3					
ALE:		1:30,000					
TE:		27/08/2013					
AWING BY:		Bojan Jevtic					
PROVED BY:		Andy Lowe					
N o L	500 I	1,000 	1,500 	2,000 m			

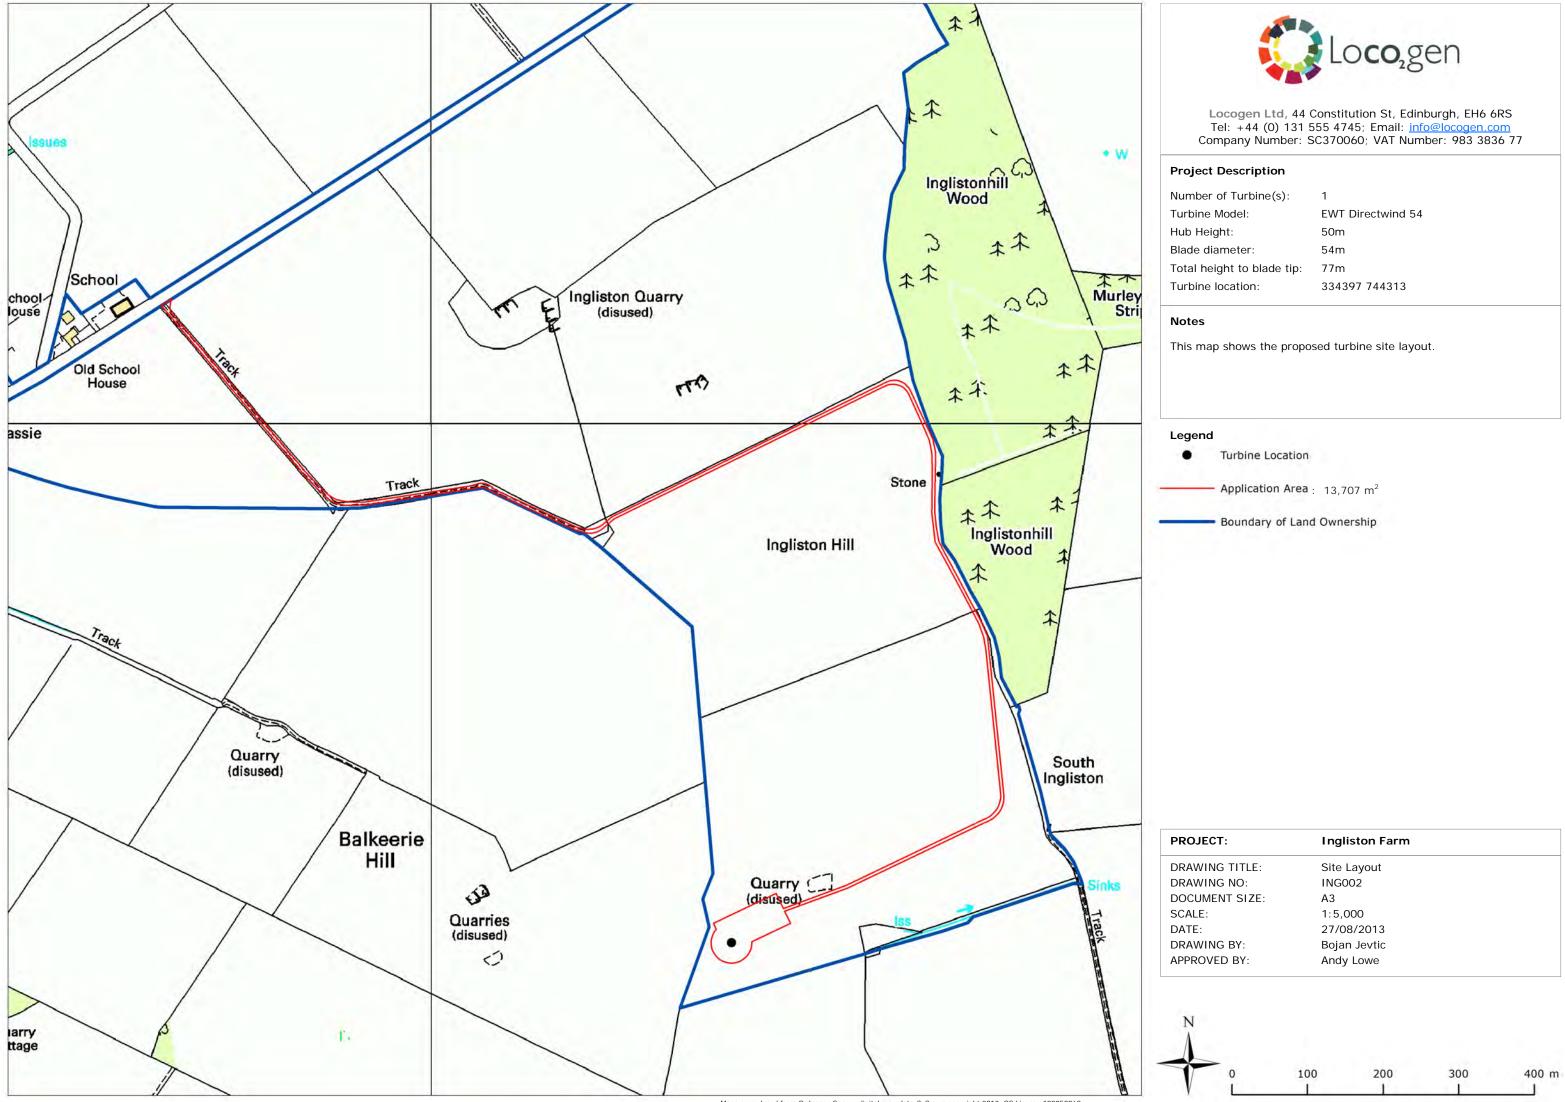


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mber of Turbine(s):	1
bine Model:	EWT Directwind 54
) Height:	50m
de diameter:	54m
al height to blade tip:	77m
bine location:	334397 744313

OJECT:	Ingliston Farm	
AWING TITLE:	Site Layout	
AWING NO:	ING002	
CUMENT SIZE:	A3	
ALE:	1:5,000	
TE:	27/08/2013	
AWING BY:	Bojan Jevtic	
PROVED BY:	Andy Lowe	




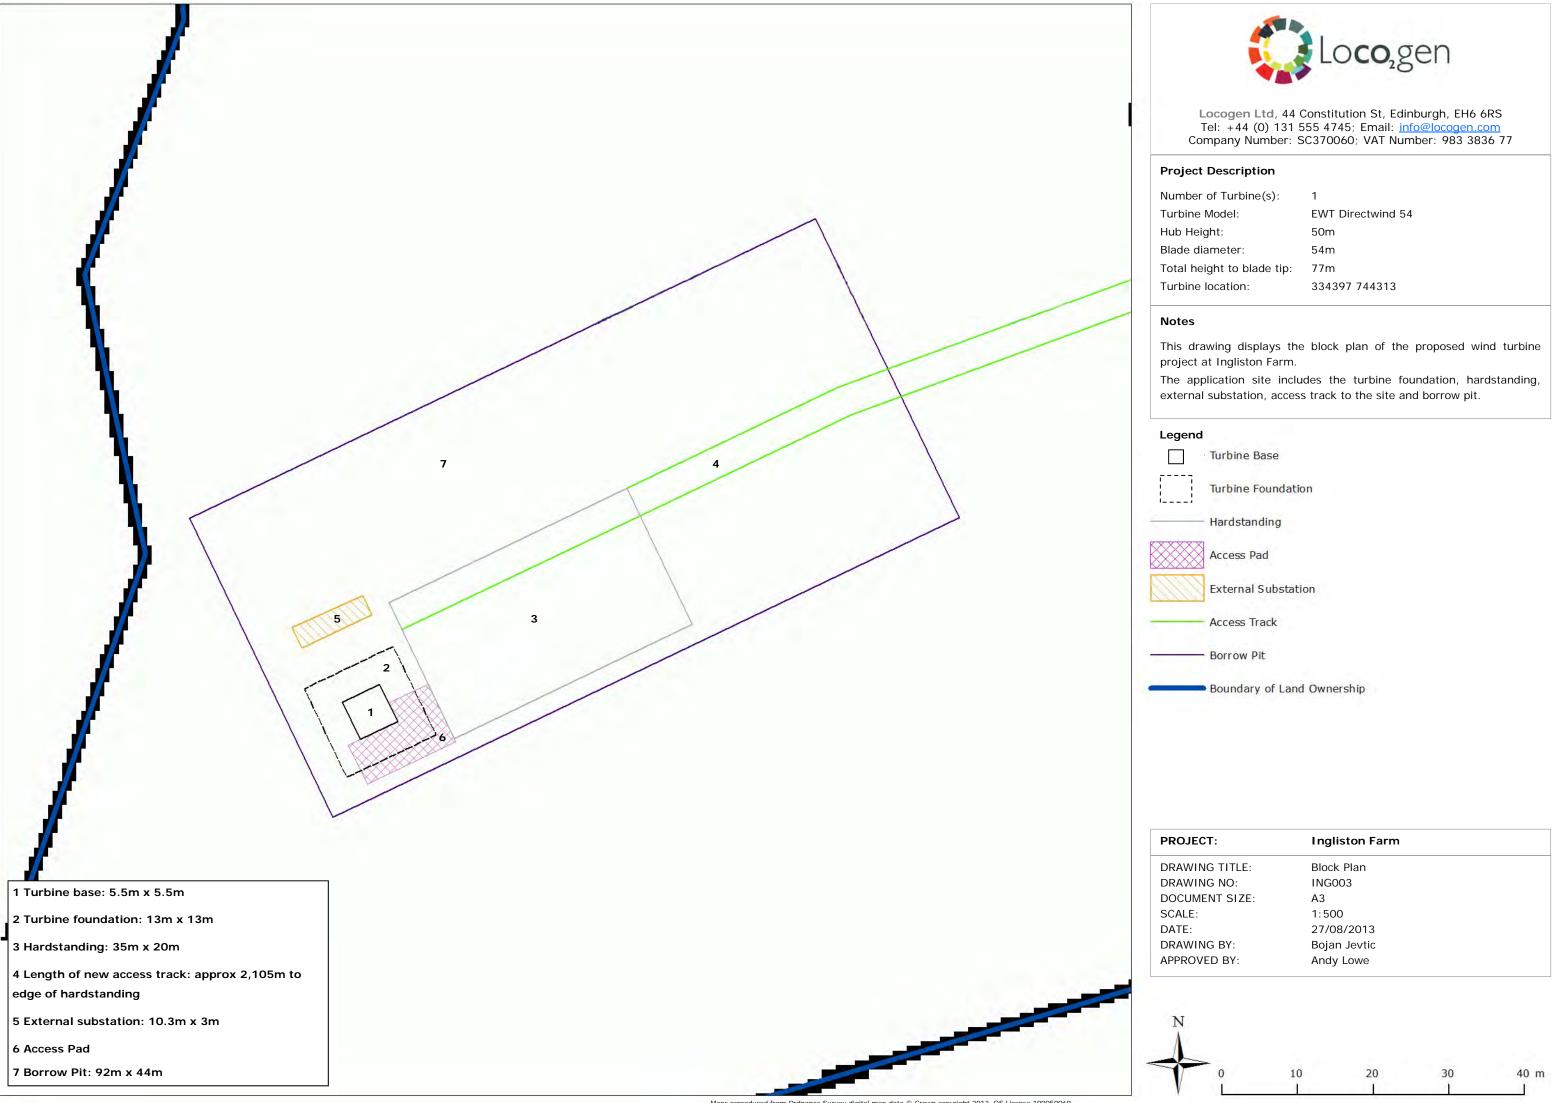


nber of Turbine(s):	1
bine Model:	EWT Directwind 54
Height:	50m
de diameter:	54m
al height to blade tip:	77m
bine location:	334397 744313

egend	
	Turbine Base
!	Turbine Foundation
	Hardstanding
	Access Pad
	External Substation
_	Access Track
-	Borrow Pit
	Boundary of Land Ownership

OJECT:	Ingliston Farm	
AWING TITLE:	Block Plan	
AWING NO:	ING003	
CUMENT SIZE:	A3	
ALE:	1:500	
TE:	27/08/2013	
AWING BY:	Bojan Jevtic	
ROVED BY:	Andy Lowe	

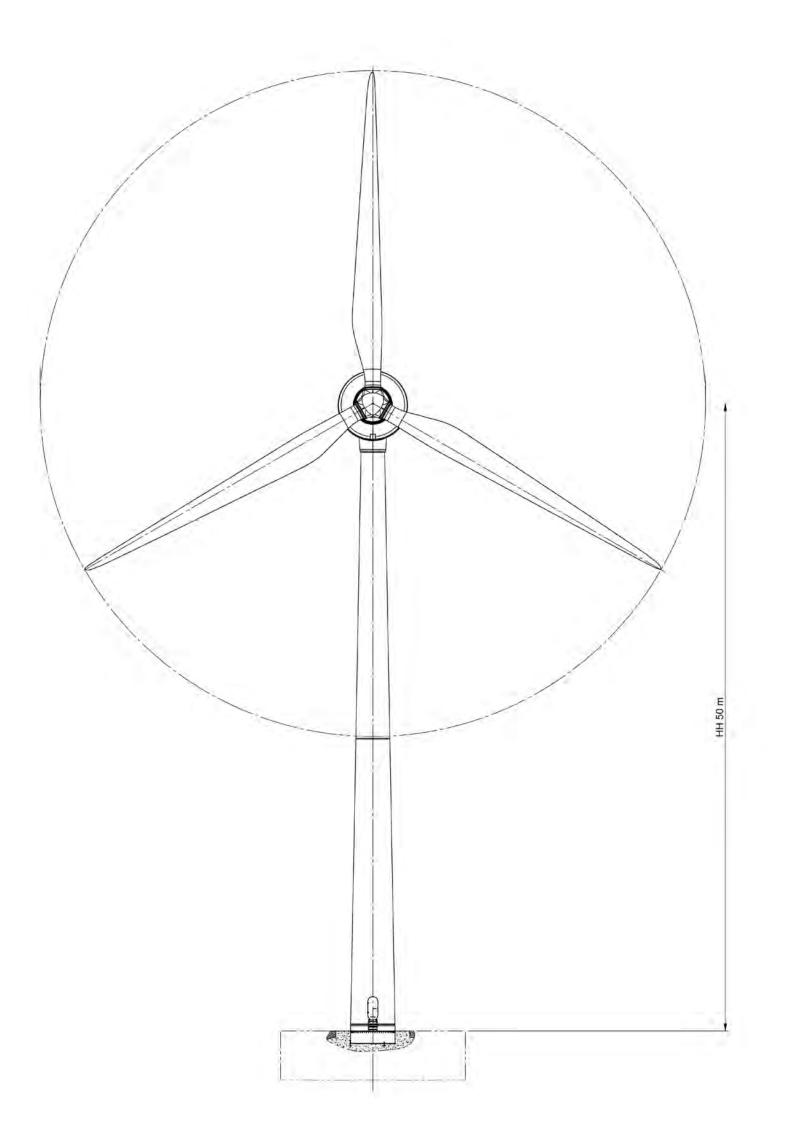

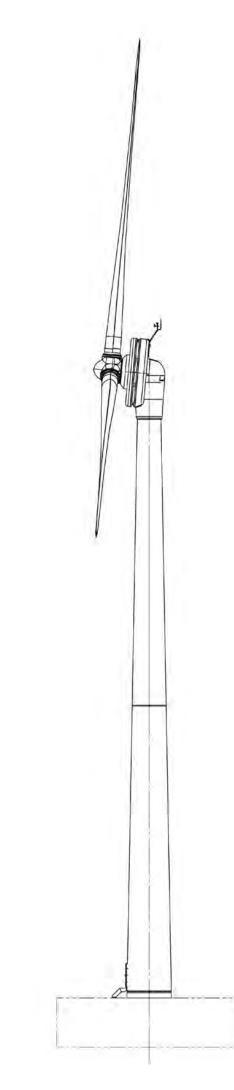

Num

Turbi Hub Blade Total Turb

Notes

DRA\ DRA\ DOC

SCA DATE DRA\ APPR



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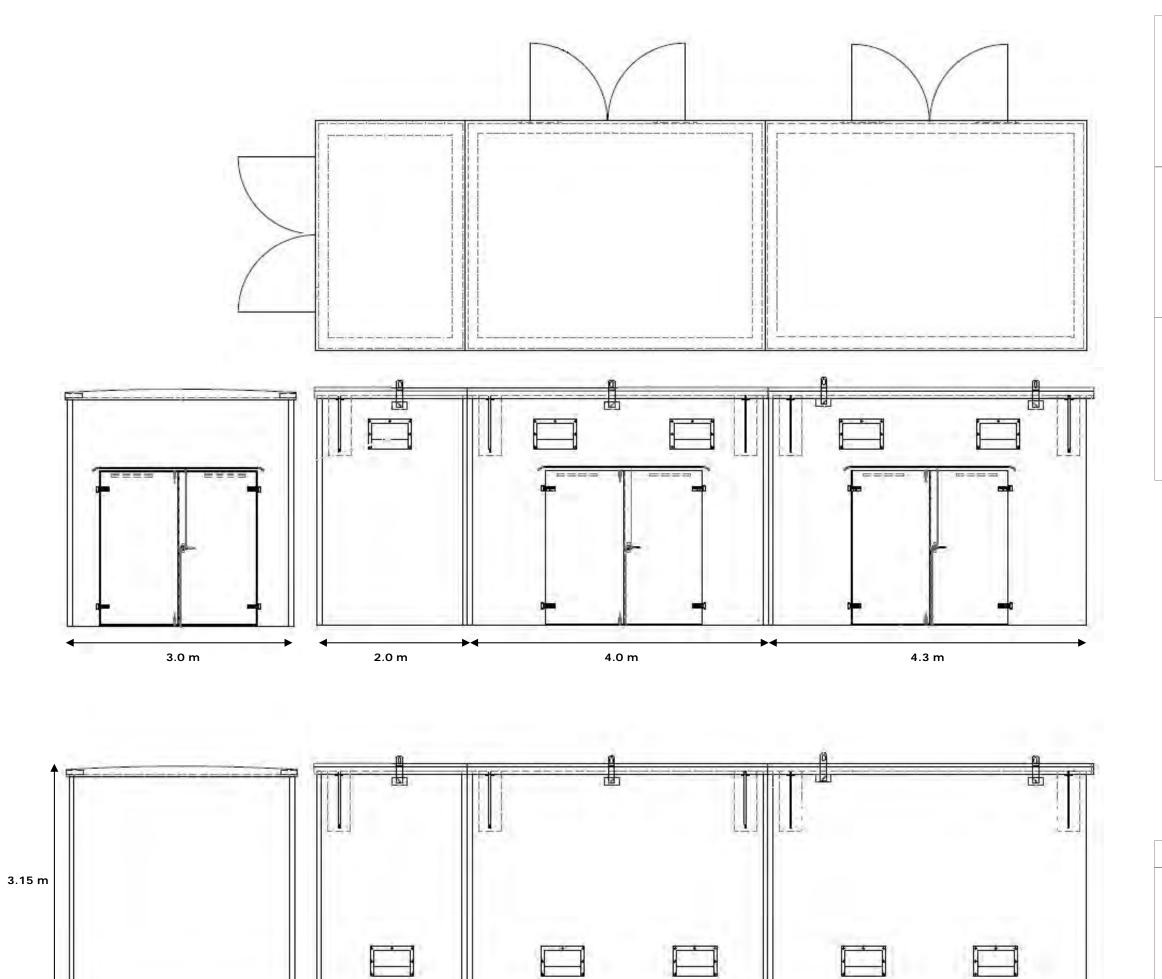
Project Description

nber of Turbine(s):	1
bine Model:	EWT Directwind 54
Height:	50m
de diameter:	54m
al height to blade tip:	77m
bine location:	334397 744313

This drawing details the elevation of the proposed wind turbine.

PROJECT:	Ingliston Farm
DRAWING TITLE:	Wind Turbine Elevation Drawings
DRAWING NO:	ING004
DOCUMENT SIZE:	A3
SCALE:	1:300
DATE:	27/08/2013
DRAWING BY:	Bojan Jevtic
APPROVED BY:	Andy Lowe

0	5	10	15	20 m
L		1		





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Project Description

Number of Turbine(s):	1
Turbine Model:	EWT Directwind 54
Hub Height:	50m
Blade diameter:	54m
Total height to blade tip:	77m
Turbine location:	334397 744313

Notes

This drawing shows the elevation and floor plan of the external substation building, as required by Scottish and Southern Energy.

The building will house the transformer, switch gear and safety equipment. The building will be constructed from Glass Reinforced Plastic (GRP) and painted green.

PROJECT:	Ingliston Farm
DRAWING TITLE:	External Substation
DRAWING NO:	ING005
DOCUMENT SIZE:	A3
SCALE:	1:50
DATE:	27/08/2013
DRAWING BY:	Bojan Jevtic
APPROVED BY:	Andy Lowe

0	1	2	3	4 m
1	1	1	-	1



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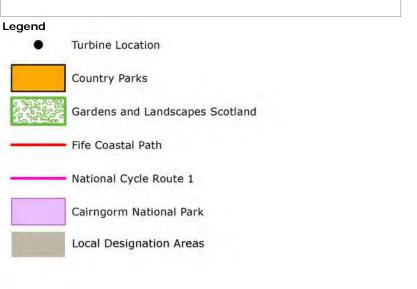
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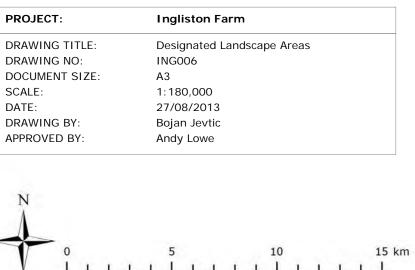
Project Description


Number of Turbine(s):	1
Turbine Model:	EWT Directwind 54
Hub Height:	50m
Blade diameter:	54m
Total height to blade tip:	77m
Turbine location:	334397 744313

Notes

This map shows the designated landscape areas within 25km of the proposed site: country parks, gardens and designed landscapes, popular walking and cycling routes and local designated areas. Radii: 5, 10, 15, 20 and 25km





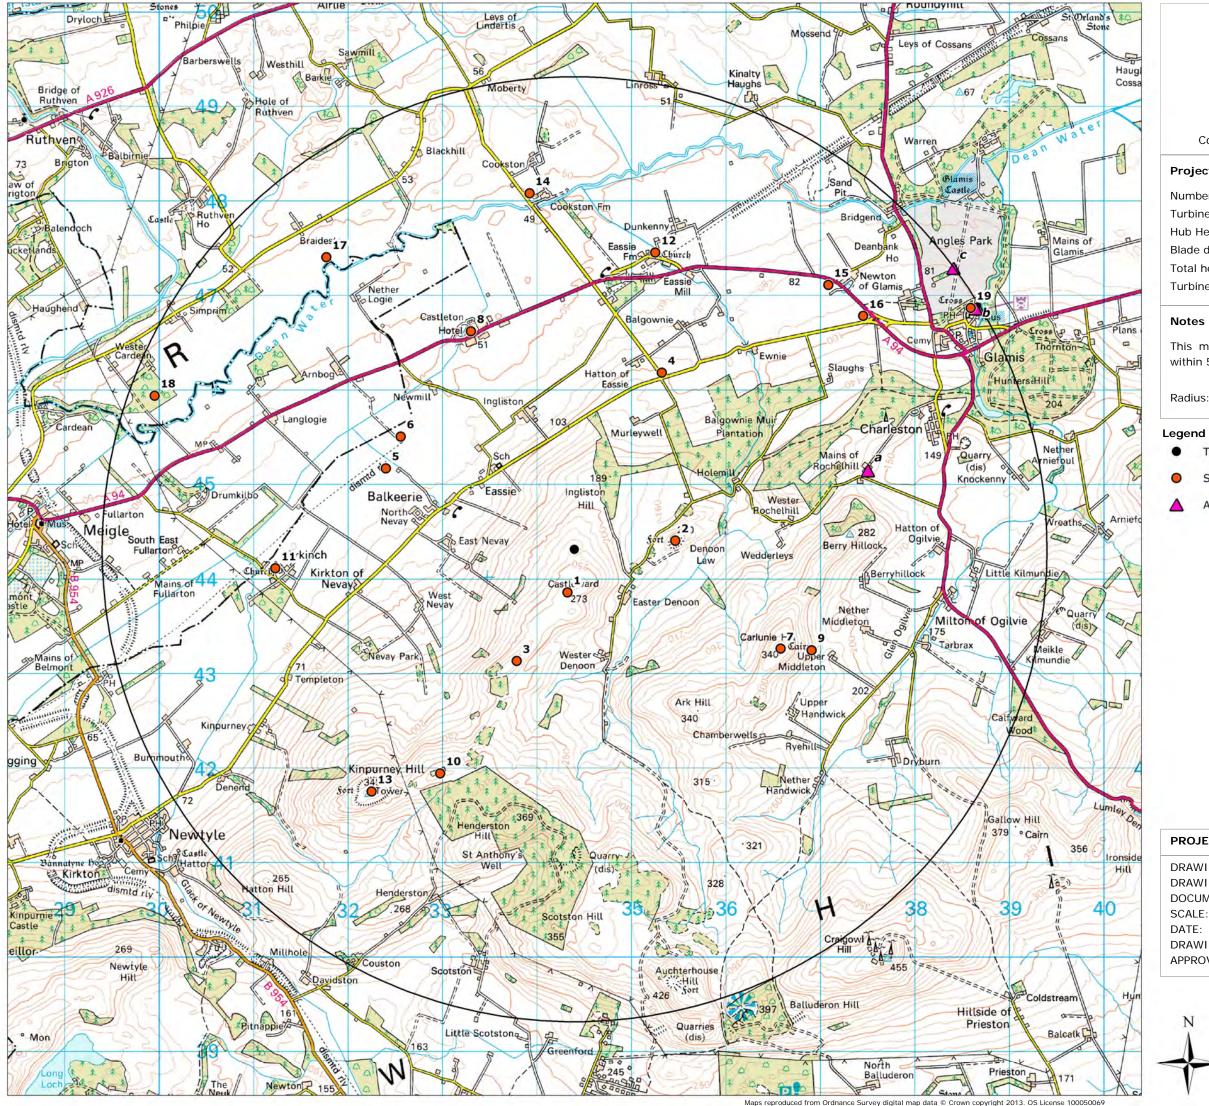

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Project Description

nber of Turbine(s):	1
bine Model:	EWT Directwind 54
Height:	50m
de diameter:	54m
al height to blade tip:	77m
bine location:	334397 744313

This map shows the Scheduled Monuments and A-Listed Buildings within 5km of the proposed wind turbine site.

Radius: 5km

- **Turbine Location**
- Scheduled Monuments
- A Listed Buildings

PROJECT:	Ingliston Farm
DRAWING TITLE:	Cultural Heritage
DRAWING NO:	ING007
DOCUMENT SIZE:	A3
SCALE:	1:40,000
DATE:	27/08/2013
DRAWING BY:	Bojan Jevtic
APPROVED BY:	Andy Lowe
N o	1 2 3 km

ID	Scheduled Monuments	Easting	Northing	Distance from turbine (km)
1	Castleward, burial mound	334323	743859	0.5
2	Denoon Law, fort	335464	744402	1.1
3	Wester Denoon, burial mound	333787	743130	1.3
4	Hatton of Eassie, ring-ditch	335322	746180	2.1
5	Balkeerie, unenclosed settlement	332401	745167	2.2
6	Newmill, ring ditch	332559	745505	2.2
7	Carlunie Hill, cairn	336578	743261	2.4
8	Castleton Motte	333300	746618	2.6
9	Carlunie Hill, hut platforms	336907	743245	2.7
10	West Nevay, burial mound	332975	741941	2.8
11	Nevay Church, Kirkinch	331230	744111	3.2
12	Eassie Old Church and cross slab	335252	747453	3.3
13	Kinpurney Hill, fort	332250	741749	3.3
14	Cookston Farm, enclosure	333921	748079	3.8
15	Newton of Glamis, unenclosed settlement	337083	747110	3.9
16	Newton of Glamis, enclosure	337453	746780	3.9
17	Braideston, enclosures	331770	747402	4.1
18	Cardean, Roman camps	329954	745937	4.7
19	Glamis Manse, cross slab	338591	746865	4.9

Easting

337502

338644

338407

Northing

745142

746855

747286

ID A - Listed Buildings

Strathmore Aisle

Glamis Castle, Dovecot

а

b

С

Mains Of Rochelhill, Dovecot

Glamis, Kirkwynd, St Fergus's Church,

Pr	oJ
Nι	ım

Turbi Hub Blade Total

Turb

Notes

PRO

Distance from turbine

(km)

3.2

4.9

5.0

DRA\ DOC SCAL DATE DRA\ APPR

DRA\




Locogen Ltd, 44 Constitution St, Edinburgh, EH6 6RS Tel: +44 (0) 131 555 4745; Email: <u>info@locogen.com</u> Company Number: SC370060; VAT Number: 983 3836 77

Project Description

mber of Turbine(s):	1
bine Model:	EWT Directwind 54
) Height:	50m
de diameter:	54m
al height to blade tip:	77m
bine location:	334397 744313

This table provides a list of Scheduled Monuments and A-Listed Buildings shown in the Cultural Heritage drawing ING007.

OJECT:	Ingliston Farm
AWING TITLE:	List of Cultural Heritage Sites
AWING NO:	ING008
CUMENT SIZE:	A3
ALE:	n/a
TE:	27/08/2013
AWING BY:	Bojan Jevtic
PROVED BY:	Andy Lowe

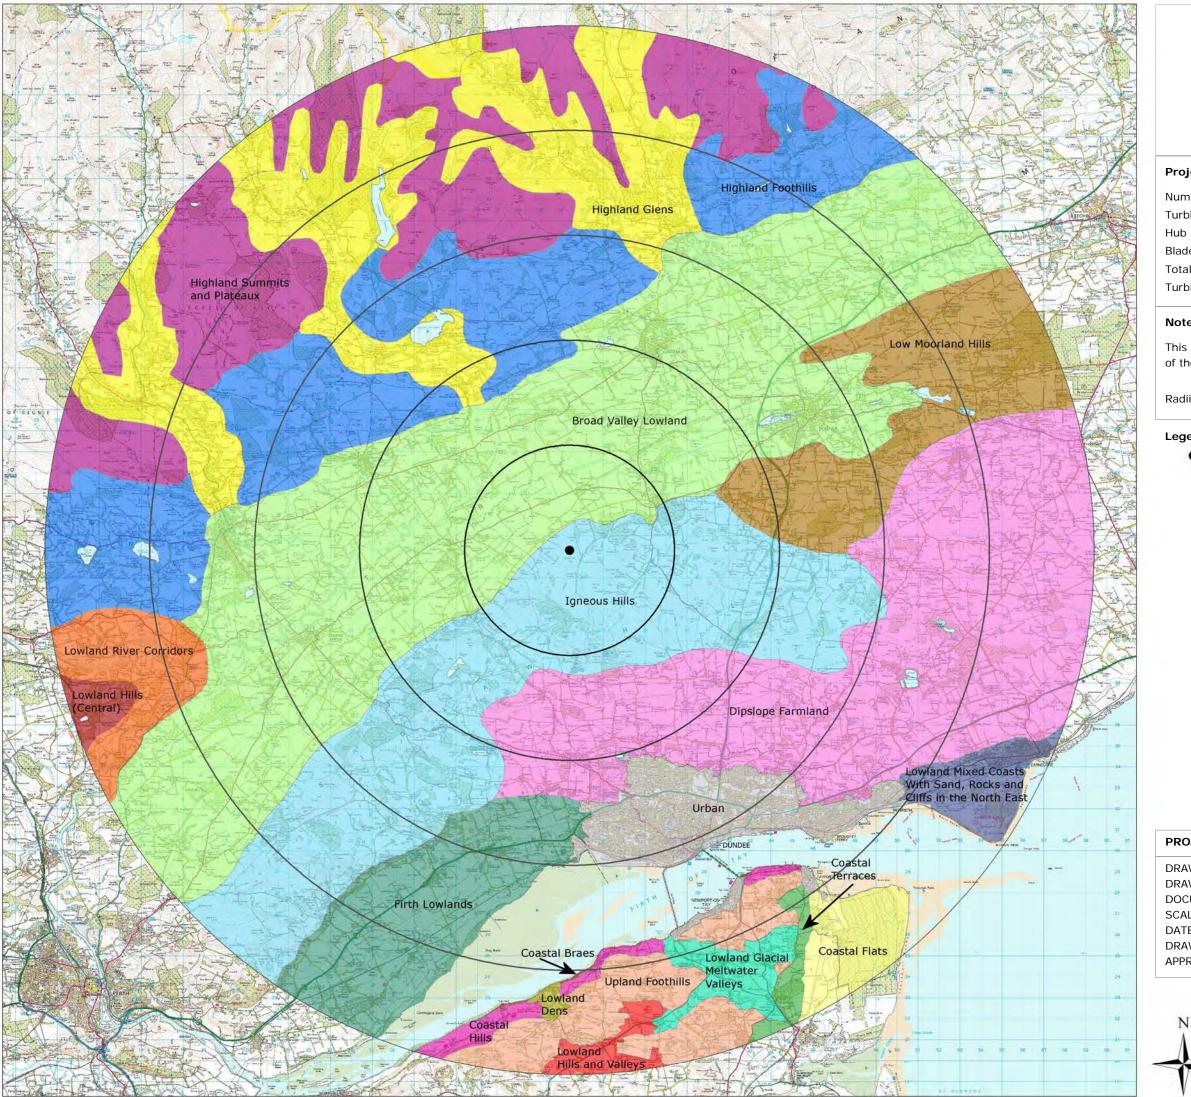

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Project Description

mber of Turbine(s):	1
bine Model:	EWT Directwind 54
) Height:	50m
de diameter:	54m
al height to blade tip:	77m
bine location:	334397 744313

Notes


This map shows the various Landscape Character Areas within 25km of the proposed wind turbine site.

Radii: 5, 10, 15, 20 and 25km

Legend •

Turbine Location

ROJECT:	Ingliston Farm
AWING TITLE:	Landscape Character Type
AWING NO:	ING009
CUMENT SIZE:	A3
ALE:	1:180,000
TE:	27/08/2013
AWING BY:	Bojan Jevtic
PROVED BY:	Andy Lowe
N	
• •	5 10 15 km

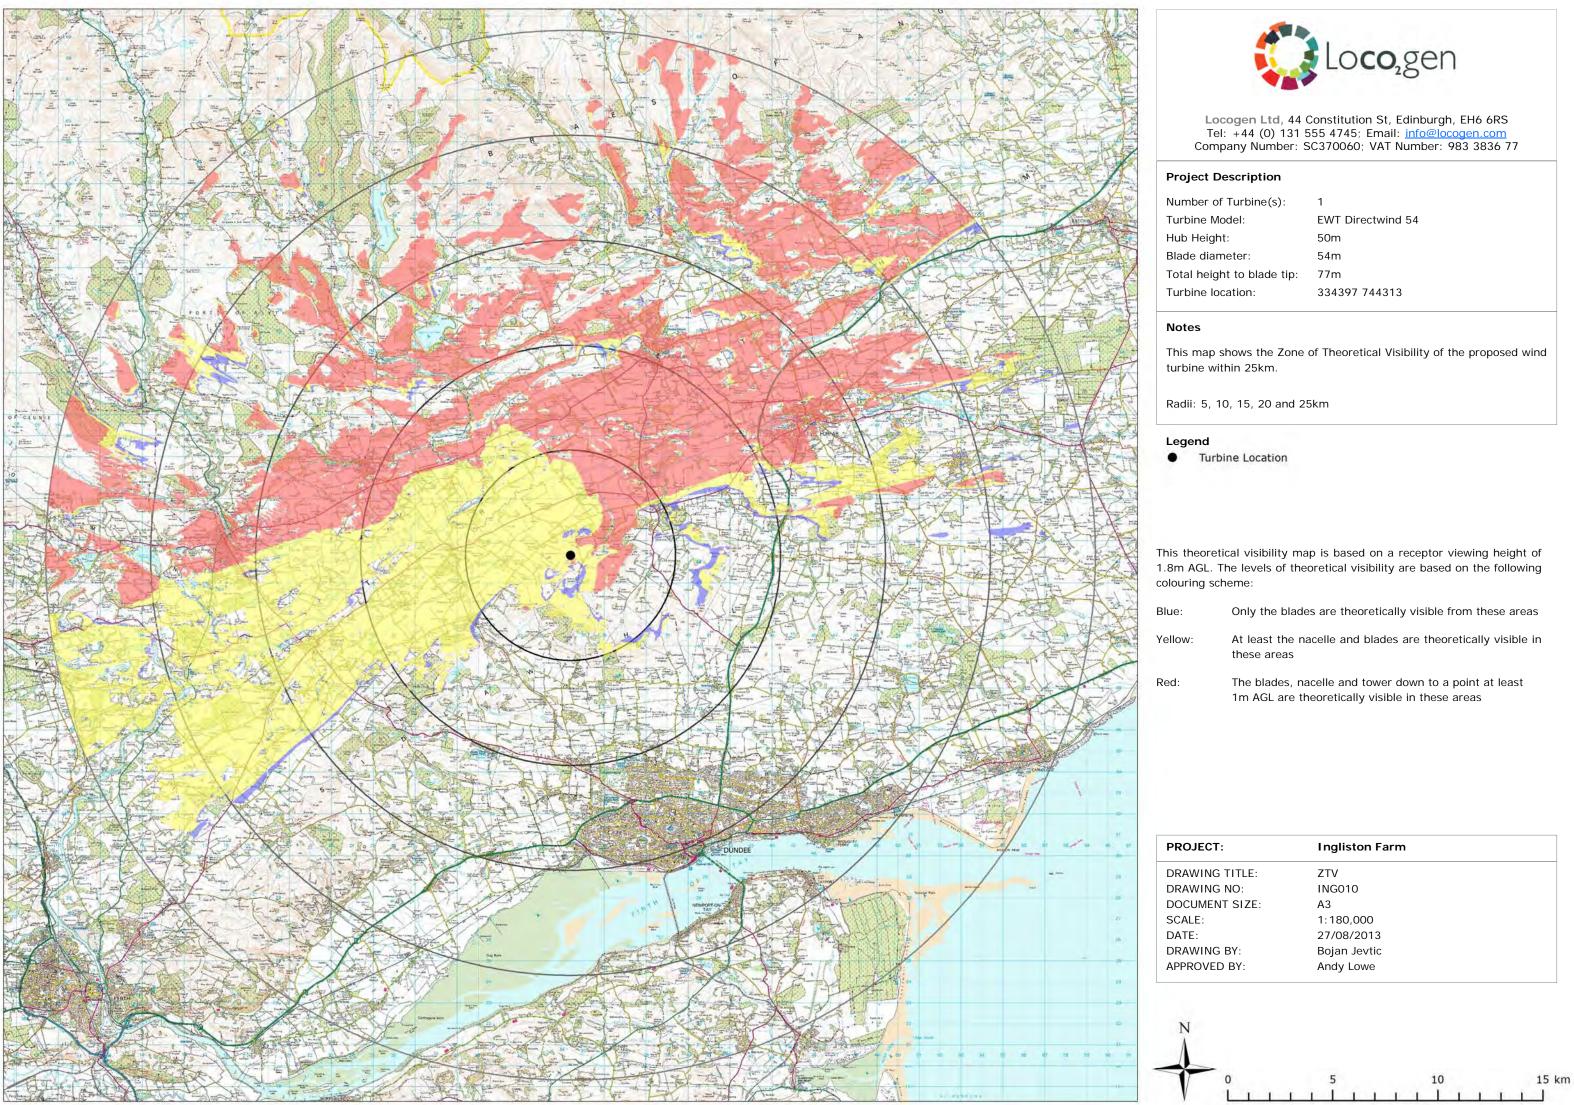


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nber of Turbine(s):	1
bine Model:	EWT Directwind 54
Height:	50m
de diameter:	54m
al height to blade tip:	77m
bine location:	334397 744313

	–	
OJECT:	Ingliston Farm	
AWING TITLE:	ZTV	
AWING NO:	ING010	
CUMENT SIZE:	A3	
ALE:	1:180,000	
TE:	27/08/2013	
AWING BY:	Bojan Jevtic	
PROVED BY:	Andy Lowe	



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Project Description

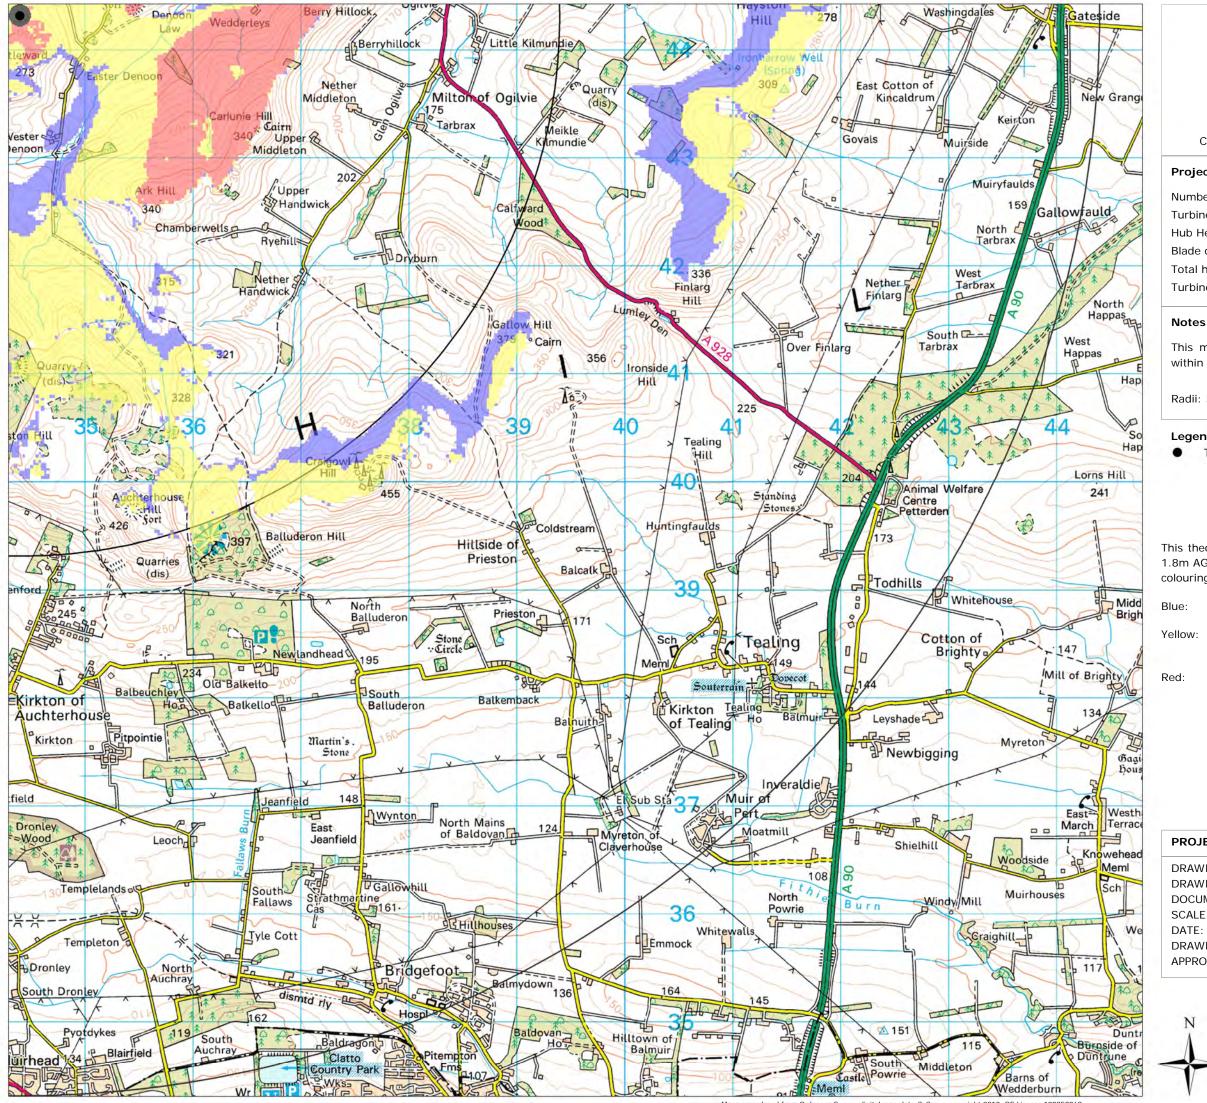nber of Turbine(s):	1
bine Model:	EWT Directwind 54
Height:	50m
de diameter:	54m
al height to blade tip:	77m
bine location:	334397 744313

This map shows the proposed turbine Zone of Theoretical Visibility within 10km of the proposed site in a south east direction.

Radii: 5 and 10km

Legend

Turbine Location


This theoretical visibility map is based on a receptor viewing height of 1.8m AGL. The levels of theoretical visibility are based on the following colouring scheme:

Only the blades are theoretically visible from these areas

At least the nacelle and blades are theoretically visible in these areas

> The blades, nacelle and tower down to a point at least 1m AGL are theoretically visible in these areas

OJECT:	Ingliston Farm	
AWING TITLE:	ZTV 10km South East	
AWING NO:	ING011	
CUMENT SIZE:	A3	
ALE:	1:35,000	
TE:	27/08/2013	
AWING BY:	Bojan Jevtic	
PROVED BY:	Andy Lowe	

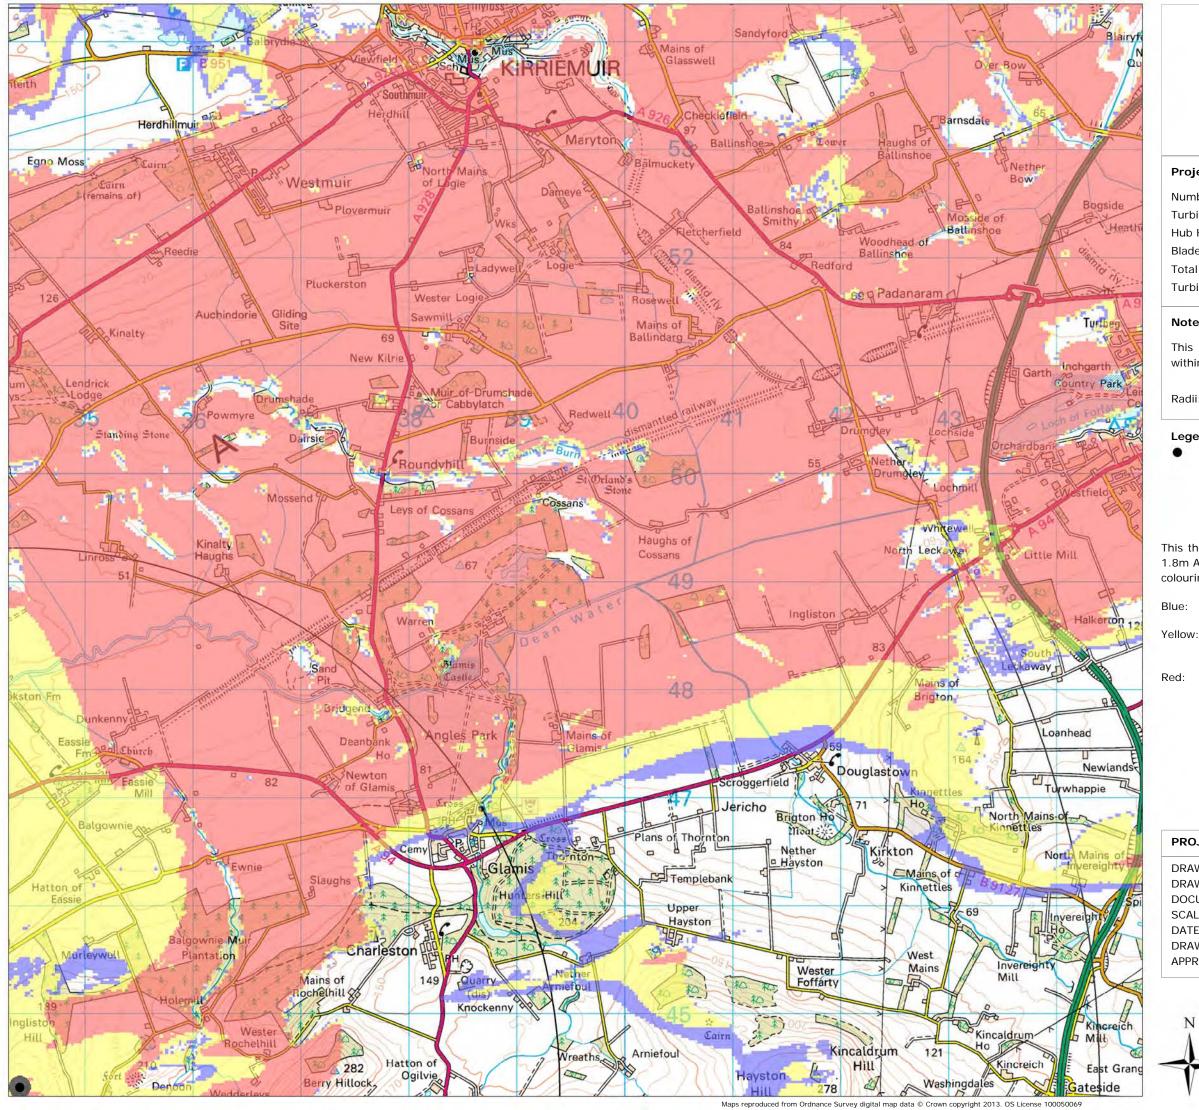

N

Legend .

This theoretical visibility map is based on a receptor viewing height of 1.8m AGL. The levels of theoretical visibility are based on the following colouring scheme:

Blue:

PRC



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Project Description

nber of Turbine(s):	1
bine Model:	EWT Directwind 54
Height:	50m
de diameter:	54m
al height to blade tip:	77m
bine location:	334397 744313

Notes

This map shows the proposed turbine Zone of Theoretical Visibility within 10km of the proposed site in a north east direction.

Radii: 5 and 10km


Turbine Location

Only the blades are theoretically visible from these areas

At least the nacelle and blades are theoretically visible in these areas

> The blades, nacelle and tower down to a point at least 1m AGL are theoretically visible in these areas

AWING TITLE:		
	ZTV 10km North East	
AWING NO:	ING012	
CUMENT SIZE:	A3	
ALE:	1:35,000	
TE:	27/08/2013	
AWING BY:	Bojan Jevtic	
PROVED BY:	Andy Lowe	

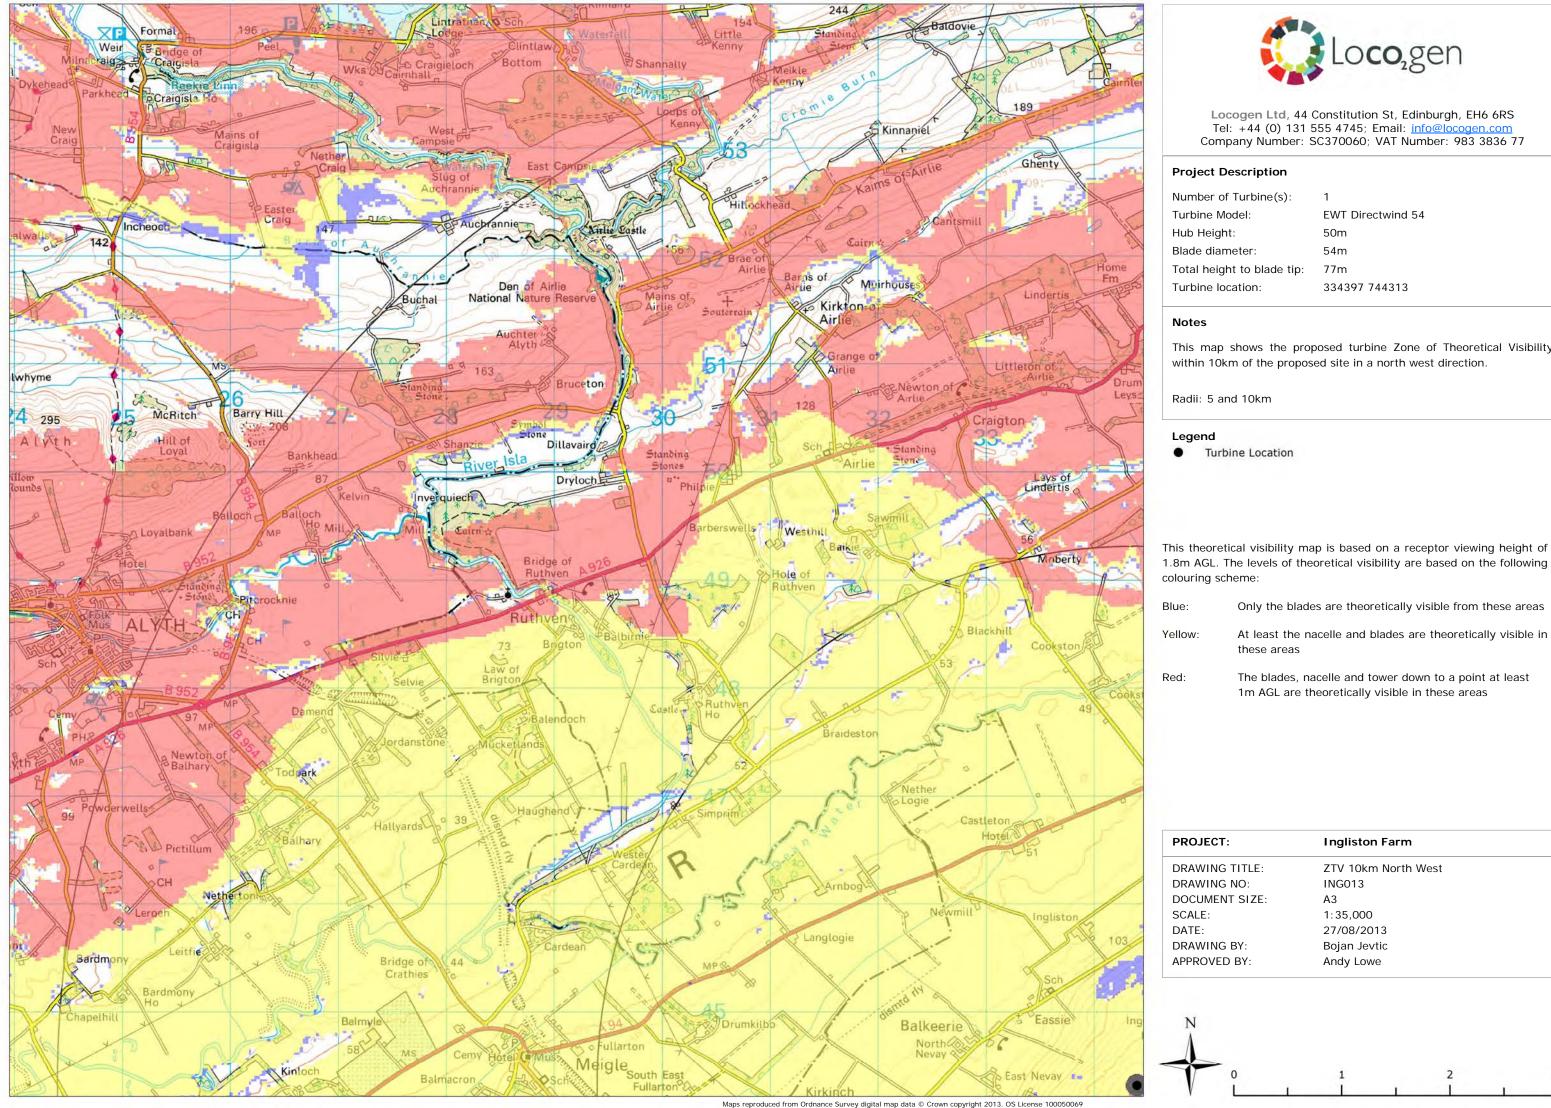

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nber of Turbine(s):	1
bine Model:	EWT Directwind 54
Height:	50m
de diameter:	54m
al height to blade tip:	77m
bine location:	334397 744313

This map shows the proposed turbine Zone of Theoretical Visibility


1.8m AGL. The levels of theoretical visibility are based on the following

Only the blades are theoretically visible from these areas

At least the nacelle and blades are theoretically visible in

The blades, nacelle and tower down to a point at least

10km North West 13
13
,000
8/2013
n Jevtic
Lowe

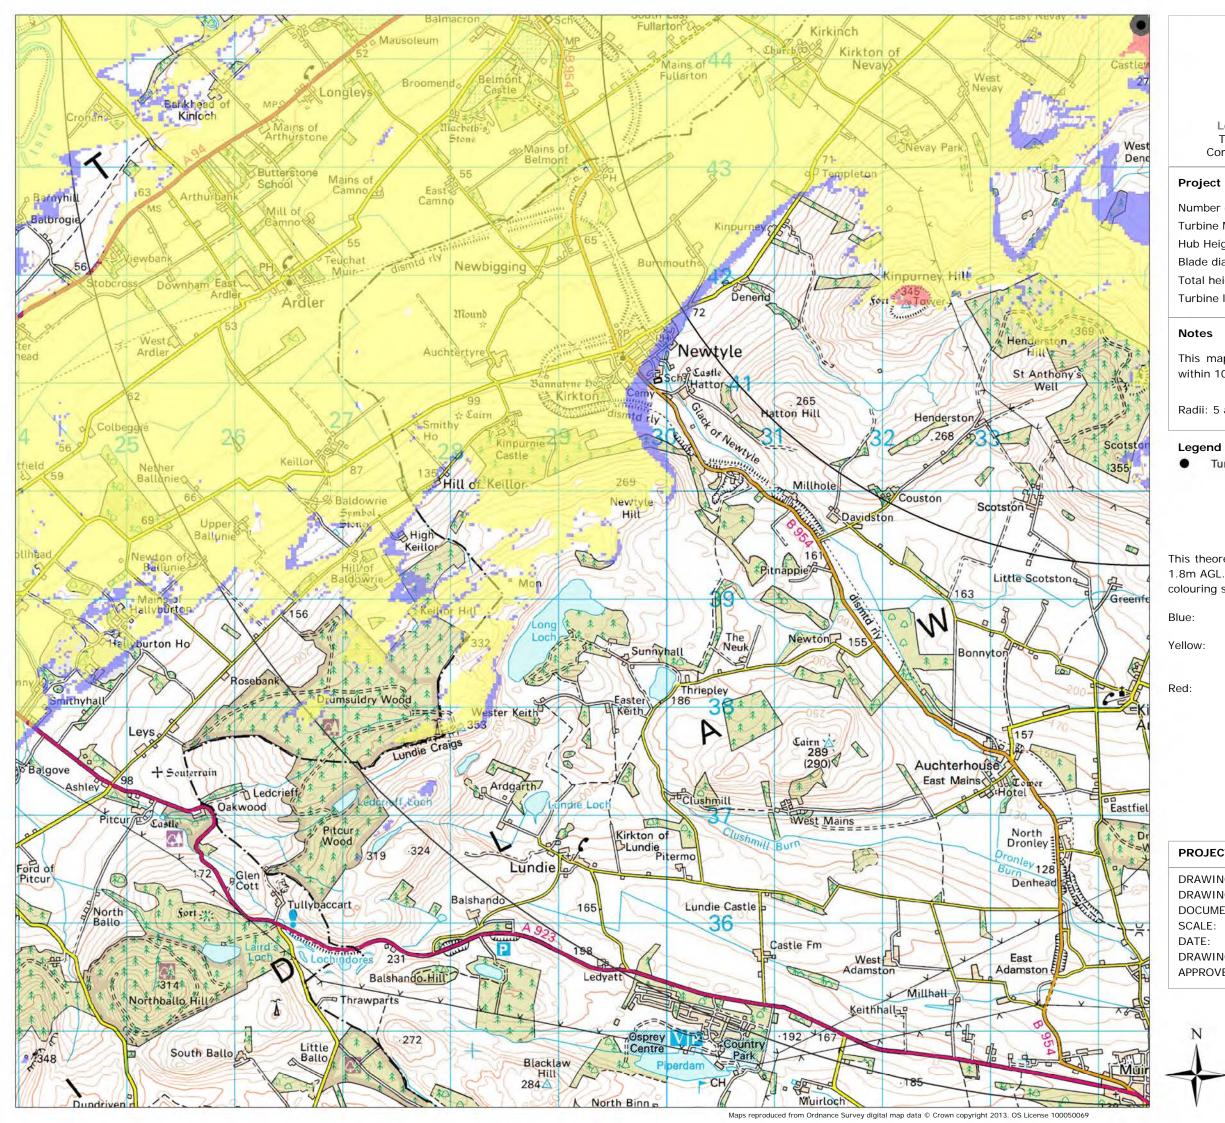



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Project Description

nber of Turbine(s):	1
bine Model:	EWT Directwind 54
Height:	50m
de diameter:	54m
al height to blade tip:	77m
bine location:	334397 744313

This map shows the proposed turbine Zone of Theoretical Visibility within 10km of the proposed site in a south west direction.

Radii: 5 and 10km

Turbine Location

This theoretical visibility map is based on a receptor viewing height of 1.8m AGL. The levels of theoretical visibility are based on the following colouring scheme:


Only the blades are theoretically visible from these areas

At least the nacelle and blades are theoretically visible in these areas

> The blades, nacelle and tower down to a point at least 1m AGL are theoretically visible in these areas

OJECT:	Ingliston Farm	
AWING TITLE:	ZTV 10km South West	
AWING NO:	ING014	
CUMENT SIZE:	A3	
ALE:	1:35,000	
TE:	27/08/2013	
AWING BY:	Bojan Jevtic	
PROVED BY:	Andy Lowe	



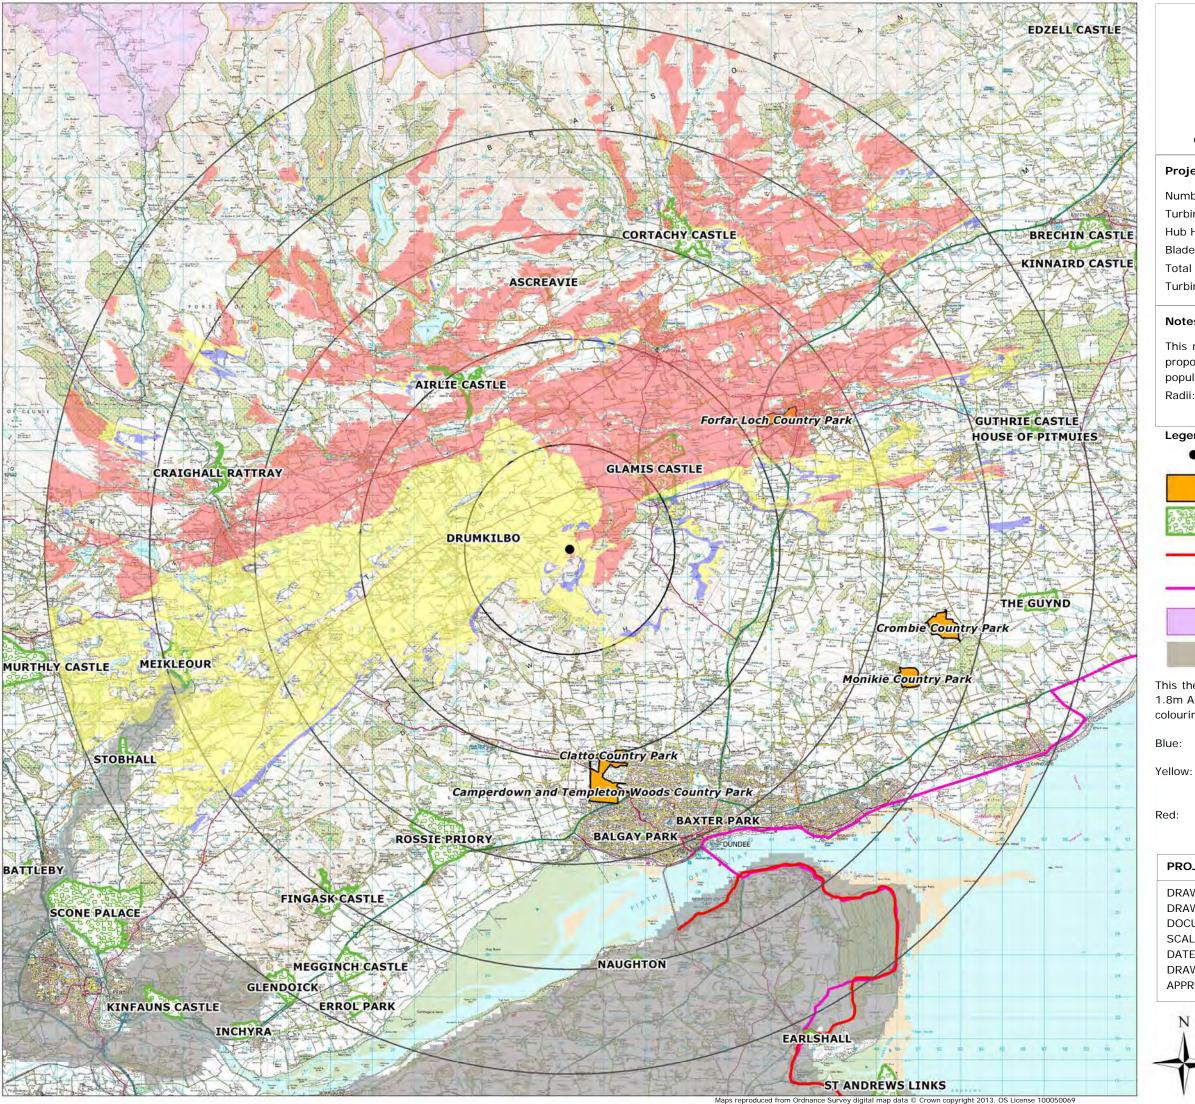




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Project Description

Number of Turbine(s):	1
Turbine Model:	EWT Directwind 54
Hub Height:	50m
Blade diameter:	54m
Total height to blade tip:	77m
Turbine location:	334397 744313

Notes

This map shows the designated landscape areas within 25km of the proposed site: country parks, gardens and designed landscapes, popular walking and cycling routes and local designated areas. Radii: 5, 10, 15, 20 and 25km

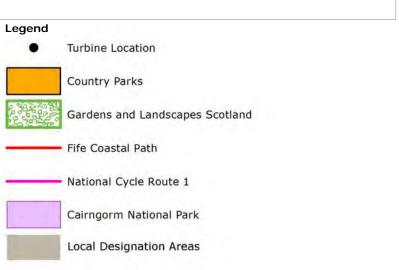


This theoretical visibility map is based on a receptor viewing height of 1.8m AGL. The levels of theoretical visibility are based on the following colouring scheme:

Only the blades are theoretically visible from these areas

At least the nacelle and blades are theoretically visible in these areas

> The blades, nacelle and tower down to a point at least 1m AGL are theoretically visible in these areas

PROJECT:	Ingliston Farm
DRAWING TITLE:	Designated Landscapes and ZTV
DRAWING NO:	ING015
DOCUMENT SIZE:	A3
SCALE:	1:180,000
DATE:	27/08/2013
DRAWING BY:	Bojan Jevtic
APPROVED BY:	Andy Lowe
	5 10 15 km

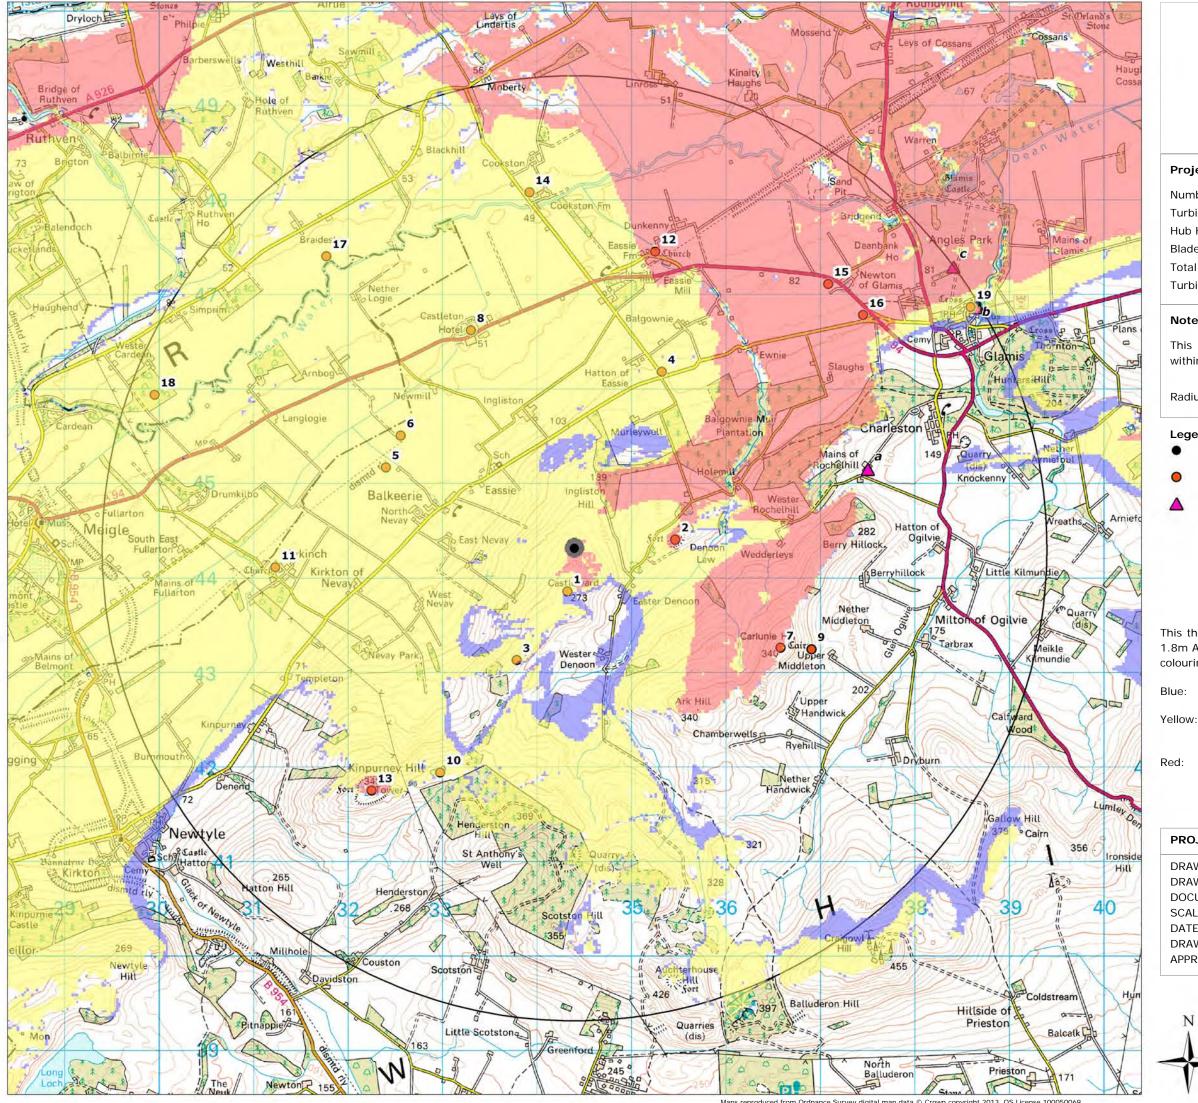

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Project Description

mber of Turbine(s):	1
bine Model:	EWT Directwind 54
) Height:	50m
de diameter:	54m
al height to blade tip:	77m
bine location:	334397 744313

Notes

This map shows the Scheduled Monuments and A-Listed Buildings within 5km of the proposed wind turbine site.

Radius: 5km

Legend

- **Turbine Location**
- Scheduled Monuments
- A Listed Buildings

This theoretical visibility map is based on a receptor viewing height of 1.8m AGL. The levels of theoretical visibility are based on the following colouring scheme:

Only the blades are theoretically visible from these areas

At least the nacelle and blades are theoretically visible in these areas

> The blades, nacelle and tower down to a point at least 1m AGL are theoretically visible in these areas

OJECT:	Ingliston Farm
AWING TITLE:	Cultural Heritage and ZTV
AWING NO:	ING016
CUMENT SIZE:	A3
ALE:	1:40,000
TE:	27/08/2013
AWING BY:	Bojan Jevtic
PROVED BY:	Andy Lowe

2



ID	Scheduled Monuments	Easting	Northing	Distance from turbine (km)
1	Castleward, burial mound	334323	743859	0.5
2	Denoon Law, fort	335464	744402	1.1
3	Wester Denoon, burial mound	333787	743130	1.3
4	Hatton of Eassie, ring-ditch	335322	746180	2.1
5	Balkeerie, unenclosed settlement	332401	745167	2.2
6	Newmill, ring ditch	332559	745505	2.2
7	Carlunie Hill, cairn	336578	743261	2.4
8	Castleton Motte	333300	746618	2.6
9	Carlunie Hill, hut platforms	336907	743245	2.7
10	West Nevay, burial mound	332975	741941	2.8
11	Nevay Church, Kirkinch	331230	744111	3.2
12	Eassie Old Church and cross slab	335252	747453	3.3
13	Kinpurney Hill, fort	332250	741749	3.3
14	Cookston Farm, enclosure	333921	748079	3.8
15	Newton of Glamis, unenclosed settlement	337083	747110	3.9
16	Newton of Glamis, enclosure	337453	746780	3.9
17	Braideston, enclosures	331770	747402	4.1
18	Cardean, Roman camps	329954	745937	4.7
19	Glamis Manse, cross slab	338591	746865	4.9

Easting

337502

338644

338407

Northing

745142

746855

747286

ID A - Listed Buildings

а

b

С

Mains Of Rochelhill, Dovecot

Glamis Castle, Dovecot

Glamis, Kirkwynd, St Fergus's Church, Strathmore Aisle

Pr	oJ
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Turbi Hub Blade Total

Turb

Notes

PRO

Distance from turbine

(km)

3.2

4.9

5.0

DRA\ DOC SCAL DATE DRA\ APPR

DRA\




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Project Description

mber of Turbine(s):	1
bine Model:	EWT Directwind 54
) Height:	50m
de diameter:	54m
al height to blade tip:	77m
bine location:	334397 744313


This table provides a list of Scheduled Monuments and A-Listed Buildings shown in the Cultural Heritage drawing ING016.

OJECT:	Ingliston Farm
AWING TITLE:	List of Cultural Heritage Sites
AWING NO:	ING017
CUMENT SIZE:	A3
ALE:	n/a
TE:	27/08/2013
AWING BY:	Bojan Jevtic
PROVED BY:	Andy Lowe



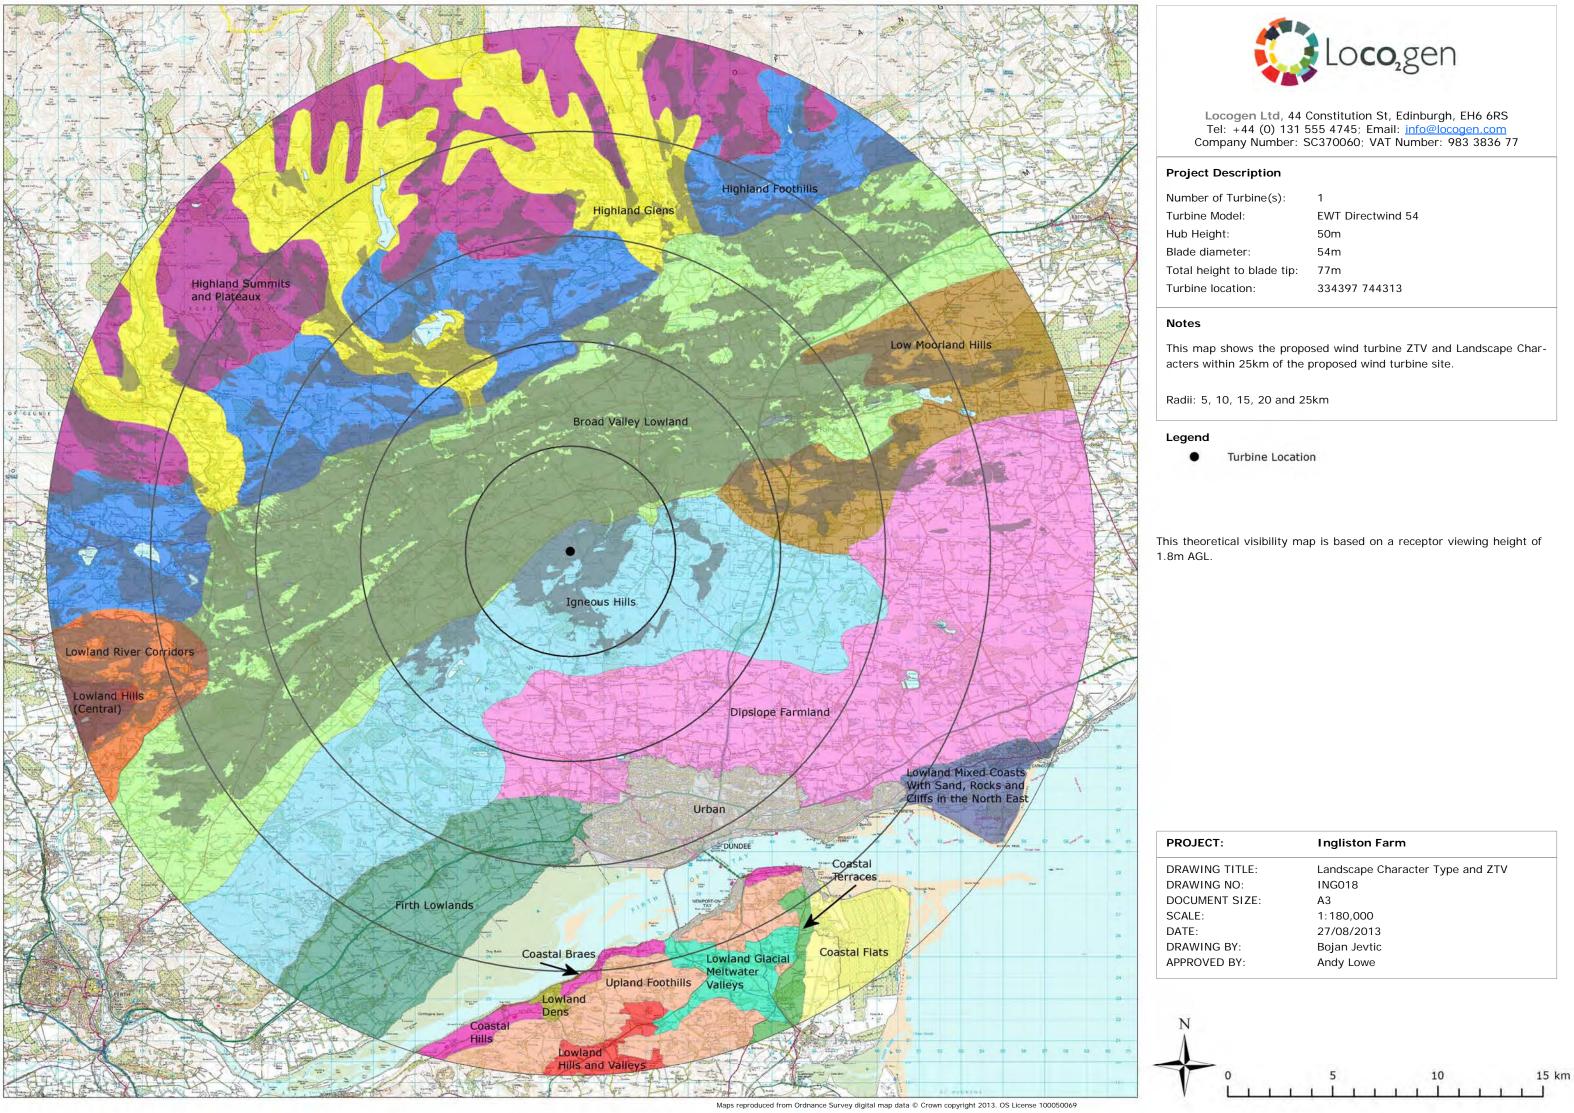

nber of Turbine(s):	1
bine Model:	EWT Directwind 54
Height:	50m
de diameter:	54m
al height to blade tip:	77m
bine location:	334397 744313

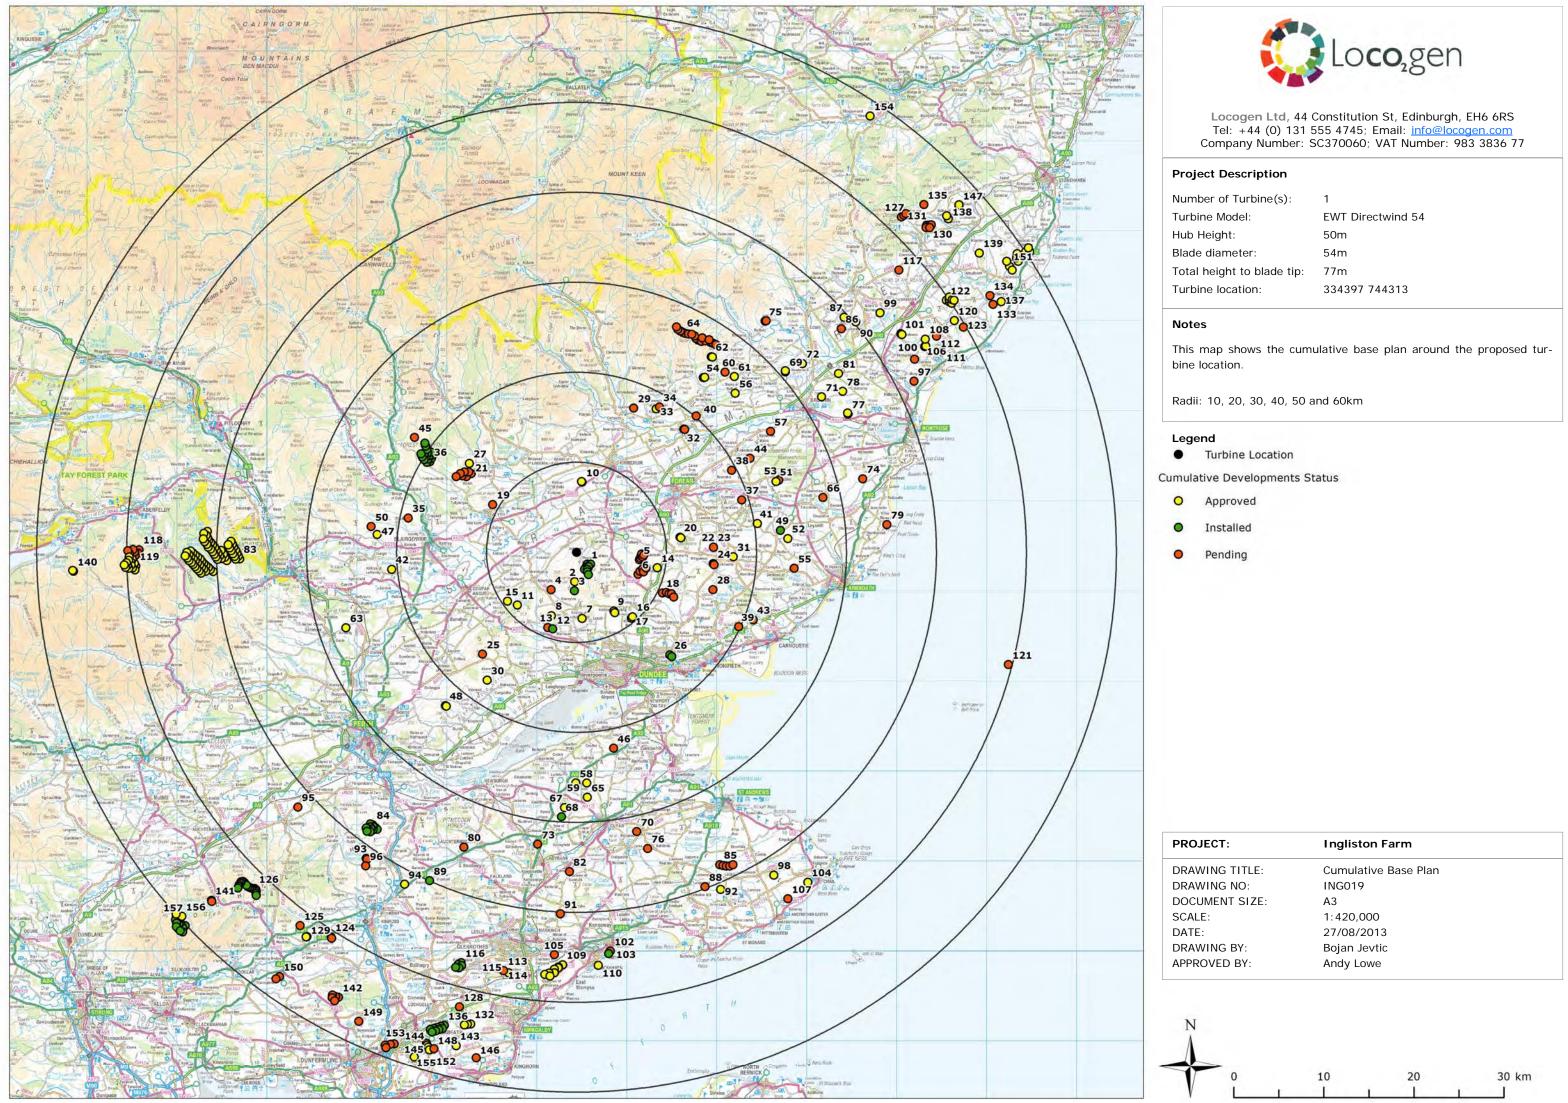

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nber of Turbine(s):	1
bine Model:	EWT Directwind 54
Height:	50m
de diameter:	54m
al height to blade tip:	77m
bine location:	334397 744313

Label	Location	Turbine Number	Tip (m)	Status	Distance (km)	Label	Location	Turbine Number	Tip (m)	Status	Distance (km)	Label	Location	Turbine Number	Tip (m)	Status	Distance (km)
1	Arkhill Wind Farm	8	79.6	Installed		54	Afflochie Farm	2		Approved	24.0	107	Cornceres Farm	1	53.7	Pending	45.1
2	Henderston Quarry	1	66.0	Approved	3.3	55	Cuthlie	1	77.0	Pending	24.3	108	Windy Corner	1		Approved	45.4
3	Scotson	1	79.6	Installed	4.3	56	Dunswood	1	77.0	Approved	25.0	109	Earlseat Wind Farm	8	120.5	Approved	45.9
4	Davidston Farm	1	62.0	Pending	5.0	57	Balnacake Farm	1	67.0	Pending	25.4	110	Methil Offshore Wind Demonstration Project	1	179.0	Approved	46.0
5	Govals Wind Farm	6	86.5	Pending	7.1	58	Newington Farm	1	41.5	Approved	25.6	111	Mains of Woodstone	1	80.0	Pending (Appeal)	46.4
6	Frawney Wind Farm	5	80.0	Pending	7.3	59	Lordscairnie Farm	1	45.7	Approved	25.7	112	South Bradieston	1	66.0	Pending	46.7
7	North Leoch	1	45.6	Approved	7.4	60	Balhall Lodge 2	1	49.0	Pending	25.9	113	Skeddoway Farm 2	1	126.0	Pending	47.2
8	West Mains Farmhouse	1	61.0	Approved	7.6	61	Balhall Lodge 1	1	47.5	Approved	26.2	114	Skeddoway Farm 1	1	110.0	Approved	47.2
9	Balkemback Farm	2	46.5	Approved	7.7	62	Glen Trusta	2	46.9	Approved	26.4	115	Noble Foods Thornton	1	110.0	Approved	47.3
10	Reedie Farm	2	46.9	Approved	7.8	63	Stewart Tower Farm	1	45.0	Approved	27.0	116	Westfield Wind Farm	5	110.0	Installed	47.4
11	House On The Hill Kettins	1	45.4	Approved	8.8	64	Nathro Hill Wind Farm	17	135.0	Pending	27.1	117	West Cairnbeg	1	77.0	Pending	47.6
12	West Adamston Farm	1	47.5	Installed	8.9	65	Pitbladdo Farm	1	51.0	Approved	27.3	118	Calliachar Wind Farm	7	110.0	Pending	48.6
13	Lundie Castle Farm	1	48.5	Pending	8.9	66	Hatton Mill Farm	1	77.0	Pending (Appeal)	28.0	119	Calliachar Wind Farm Amulree	14	109.0	Approved	49.0
14	North Tarbax	1	45.9	Approved	9.1	67	Lumbennie Hill	1	84.0	Approved	28.4	120	Redford Farm	1	53.9	Approved	49.2
15	House On The Hill	1	46.5	Approved	9.4	68	Westhall Cupar Fife	1	45.5	Installed	29.4	121	Inchcape Wind Farm - Offshore	213	215.0	Pending	49.6
16	Tealing	1	86.5	Approved	9.5	69	Balrownie Farm	2	46.5	Approved	30.7	122	Tullo Wind Farm	7	100.0	Approved	49.7
17	Former Tealing Airfield	1	86.5	Pending	9.5	70	Easter Pitscottie Farm	1	48.7	Pending	31.8	123	Paul Matthew Hill	1	99.5	Pending (Appeal)	49.7
18	Dodd Hill Wind Farm	5	126.5	Pending (Appeal)	10.6	71	East Pitforthie Farm	1	47.0	Approved	32.2	124	South Kilduff	2	45.0	Pending	50.7
19	Loyal Farm	1	47.0	Pending	10.7	72	Auchenreoch Farm	1	45.9	Approved	32.7	125	Thorntonhill	1	45.5	Pending	51.6
20	Wester Meathie Farm	2	46.6	Approved	11.6	73	Lower Melville Wood	1	85.0	Pending	32.7	126	Greenknowes Wind Farm	18		Installed	51.7
21	Bamff Wind Farm	7	111.0	Pending (Appeal)	14.6	74	Renmure Farm	1	77.0	Pending	32.9	127	Denside	3	92.5	Pending	51.9
22	Greenhillock 1	1	45.9	Approved	15.2	75	Wilton Farm	2	74.0	Pending	33.1	128	Dundonald	1	99.5	Pending	52.2
23	Greenhillock 2	1	67.0	Pending	15.2	76	North Callange Farm	1	47.0	Pending (Appeal)	33.8	129	Bankhead Farm	2	47.0	Approved	52.2
24	Drowndubbs Farm	2	46.5	Pending	15.3	77	Arrat Farm	2	46.0	Approved	33.9	130	Herscha Hill Extension	2	79.0	Pending	53.0
25	Glenbran Farm	1	56.3	Pending	15.4	78	Whitefield Of Dun Farm	1	67.0	Approved	34.6	131	Herscha Hill Cluster	3	79.6	Pending	53.2
26	Michelin Tyres	2	120.0	Installed	15.4	79	Ethie Barns Farm	1	45.0	Pending	34.6	132	Clentrie Farm (Gevens Wind Cluster)	3	99.5	Approved	53.7
27	Wester Derry Farm	1	45.0	Approved	15.5	80	Demperston Farmhouse	1	54.0	Pending	35.1	133	Craig Garbil	1	79.0	Pending (Appeal)	53.9
28	Stotfaulds Farm	1	77.0	Pending	15.7	81	Hill Of Stracathro	1	79.6	Approved	35.2	134	Peattie	1	67.0	Pending	54.1
29	Gallow Hill	1	46.5	Pending	17.2	82	Crossgates Cottages	1	49.0	Pending	35.5	135	Chapleton Farm	1	49.0	Pending	54.6
30	Outfield Farm Abernyte	1	40.0	Approved	17.3	83	Griffin Wind Farm	68	130.5	Approved	37.4	136	Little Raith Wind Farm	9	126.0	Installed	54.6
31	Lochlair Farmhouse	1	47.0	Approved	17.4	84	Lochelbank Wind Farm	12	86.5	Installed	37.8	137	Dendoldrum Farm	1	45.7	Approved	54.8
32	Kalulu House	2	44.8	Pending	18.1	85	Lingo Farm Lingo Wind Farm	5	100.0	Pending (Appeal)	38.2	138	Droop Hill	2	100.0	Approved	55.5
33	East Memus	1	86.5	Approved	18.2	86	Steelstrath Farm	1	84.0	Pending	38.5	139	Wairds of Alpity	1	79.0	Approved	55.8
34	White Top	1	86.5	Pending	18.6	87	Moss Side of Esslie	1	45.5	Approved	39.6	140	Balmacnaughton Remony	2	46.6	Approved	55.9
35	Netheraird of Glasclune	1	67.0	Pending	19.1	88	South Cassingray Farm	1	50.0	Pending	39.8	141	Glenhead Farm	2	45.0	Pending	56.1
36	Drumderg Wind Farm	16	107.0	Installed	19.1	89	Lacesston Farm	1	48.0	Installed	40.0	142	Cleish Hills Wind Farm	5	110.0	Pending	56.1
37	Newmill Of Balgavies	1	66.5	Pending	19.3	90	Gossesslie Farm	1	47.5	Approved	40.2	143	Pitkinnie Farm	2	45.0	Approved	56.4
38	West Mains Of Turin	1	49.0	Pending	19.5	91	Carriston Farm	1	56.7	Pending	40.2	144	Chemical Works	2	126.5	Pending	57.1
39	New Downie Farm	1	54.0	Pending	19.8	92	South Baldutho Farm	1		Approved	40.7	145	Chemical Works Moss- morran	2		Approved	57.2
40	Broom Farm	1	49.5	5	20.1	93	East Blair Farm	2	45.5	Pending	41.3	146	Balbie Farm	1		Pending	57.3
41	Newton Of Idvies Farm	1		Approved		94	Cuthill Towers Farm	1		Approved	41.5	147	Jacksbank	3		Approved	57.4
42	Hill Of Lethendy Farm	1	66.6			95	Drumside	1	46.0	Pending	42.0	148	Kirkton Farm Extension	1	77.0	Pending	57.4
43	Upper Balmachie Farm	1	77.0	Pending	21.0	96	Temple Hill	1	84.0	Pending	42.0	149	Lathalmond Farm	1		Pending	57.5
44	Pitkennedy Farm	1	74.0	Pending Pending	21.9		Stone of Morphie Cottage		77.0	Pending	42.0	150	Barnhill Farm Powmill	2		Pending	57.6
45	The Corb Bridge	1	84.0	(Appeal)	22.0	98	Airdrie Farm	1		Approved		151	St John's Hill Wind Farm	9		Approved	57.7
46	Wester Kilmany Farm	1	86.5		22.2	99	Brigton Farm	1		Approved Pending	42.9	152	Goathill Quarry Kingdom of Fife Commu-	1		Approved	57.7
47	East Gormack Farm	1	66.7	Approved		100	Pitbeadlie Farm	1	76.0	(Appeal)	43.3	153	nity Wind Park	4		Pending	58.3
48	Shandry Farm Rait North Mains Of Conon-	2		Approved		101	Dykelands	2		Approved	43.5	154	Shampher Cottage	1		Approved	58.4
49	syth	1	66.7	Installed	22.8	102	EFFC	1	81.0	Pending	44.5	155	Wester Bucklyvie	1	45.7	Approved	58.9
50	Easter Logie	1	47.0	Pending	23.0	103	Hydrogen Office - Methil Docks	1	81.0	Installed	44.8	156	Glendevon Resevoirs	2	102.0	Approved	59.7
51	Pickerton	1		Approved		104	Kirkmay Farm	1		Approved	44.8	157	Burnfoot Hill Wind Farm	13	102.0	Installed	60.0
52	Parkconon Farm	1		Approved		105	Balgonie	1	86.5	5	44.8						
53	Dubton Farm	1	77.0	Pending	23.9	106	Criggie Farmhouse	2	45.5	Approved	44.9						

Num Turbi Hub Blade Total

Turb

Details of cumulative developments shown in the Cumulative Base Plan drawing ING019

DRA\




Locogen Ltd, 44 Constitution St, Edinburgh, EH6 6RS Tel: +44 (0) 131 555 4745; Email: <u>info@locogen.com</u> Company Number: SC370060; VAT Number: 983 3836 77

Project Description

nber of Turbine(s):	1
bine Model:	EWT Directwind 54
Height:	50m
de diameter:	54m
al height to blade tip:	77m
bine location:	334397 744313

Notes

Ingliston Farm
Cumulative Base Plan List
ING020
A3
n/a
27/08/2013
Bojan Jevtic
Andy Lowe

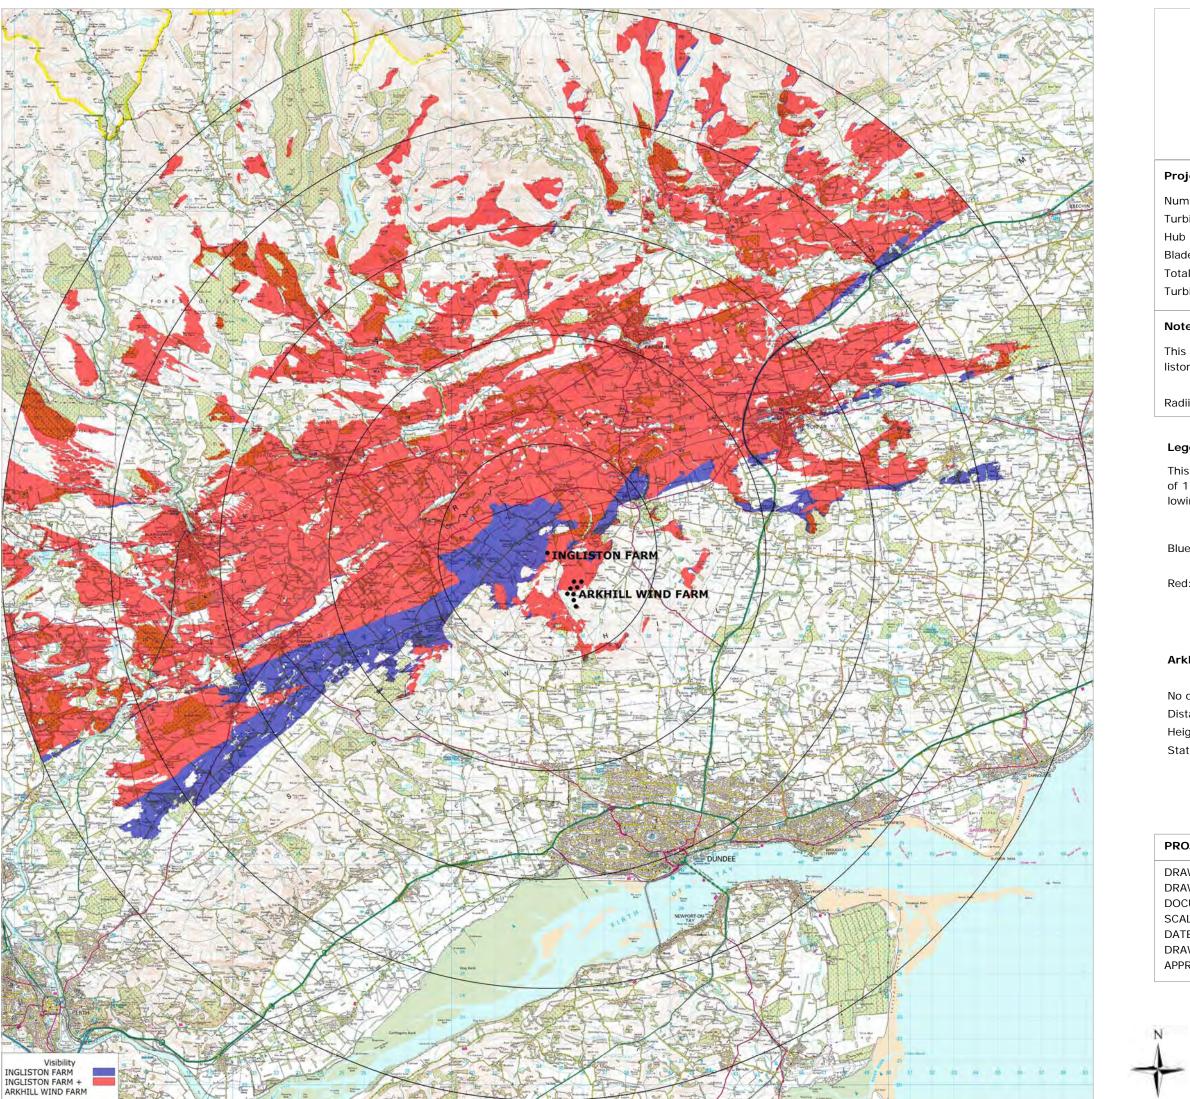

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Project Description

nber of Turbine(s):	1
bine Model:	EWT Directwind 54
Height:	50m
de diameter:	54m
al height to blade tip:	77m
bine location:	334397 744313

Notes

This map shows the cumulative zone of visibility of the proposed Ingliston Farm turbine and the operational Arkhill development.

Radii: 5, 10, 15, 20 and 25km

Legend

This theoretical visibility map is based on a receptor viewing height of 1.8m AGL. The levels of theoretical visibility are based on the following colouring scheme:

Blue: Only Ingliston Farm turbine visible


Red: At least the nacelle of the Ingliston Farm turbine and the Arkhill Wind Farm turbines will be visible

Arkhill Wind Farm details

No of turbines:	8
Distance from Ingliston Farm:	1.8km
Height to blade tip:	79.6m
Status:	Operational

OJECT:	Ingliston Farm
AWING TITLE:	Cumulative ZTV—Arkhill Wind Farm
AWING NO:	ING021
CUMENT SIZE:	A3
ALE:	1:170,000
TE:	30/08/2013
AWING BY:	Bojan Jevtic
PROVED BY:	Andy Lowe

0	5	10	

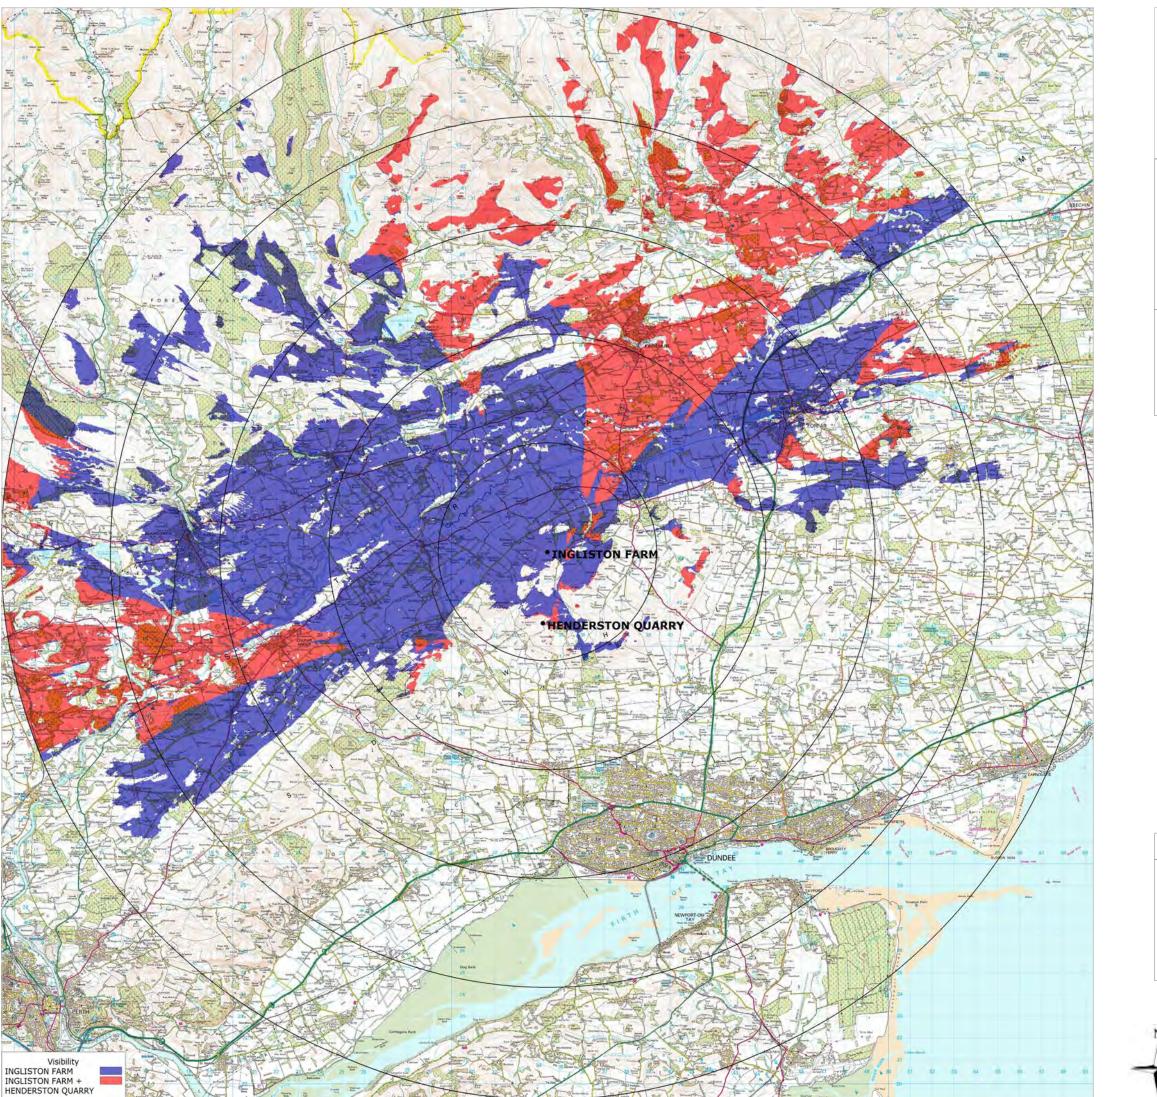

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Num

Turb Hub Blad Tota

Turb

This map shows the cumulative zone of visibility of the proposed Ingliston Farm turbine and the approved Henderston Quarry development.

This theoretical visibility map is based on a receptor viewing height of 1.8m AGL. The levels of theoretical visibility are based on the following colouring scheme:

Blue: Only Ingliston Farm turbine visible

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Project Description

nber of Turbines:	1
bine Model:	EWT Directwind 54
Height:	50m
de diameter:	54m
al height to blade tip:	77m
bine location:	334397 744313

Notes

Radii: 5, 10, 15, 20 and 25km

Legend


Red: At least the nacelle of the Ingliston Farm turbine and the Henderston Quarry turbine will be visible

Henderston Quarry details

1
3.3km
66.0m
Approved

OJECT:	Ingliston Farm
AWING TITLE:	Cumulative ZTV—Henderston Quarry
AWING NO:	ING022
CUMENT SIZE:	A3
ALE:	1:170,000
TE:	30/08/2013
AWING BY:	Bojan Jevtic
PROVED BY:	Andy Lowe

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Project Description

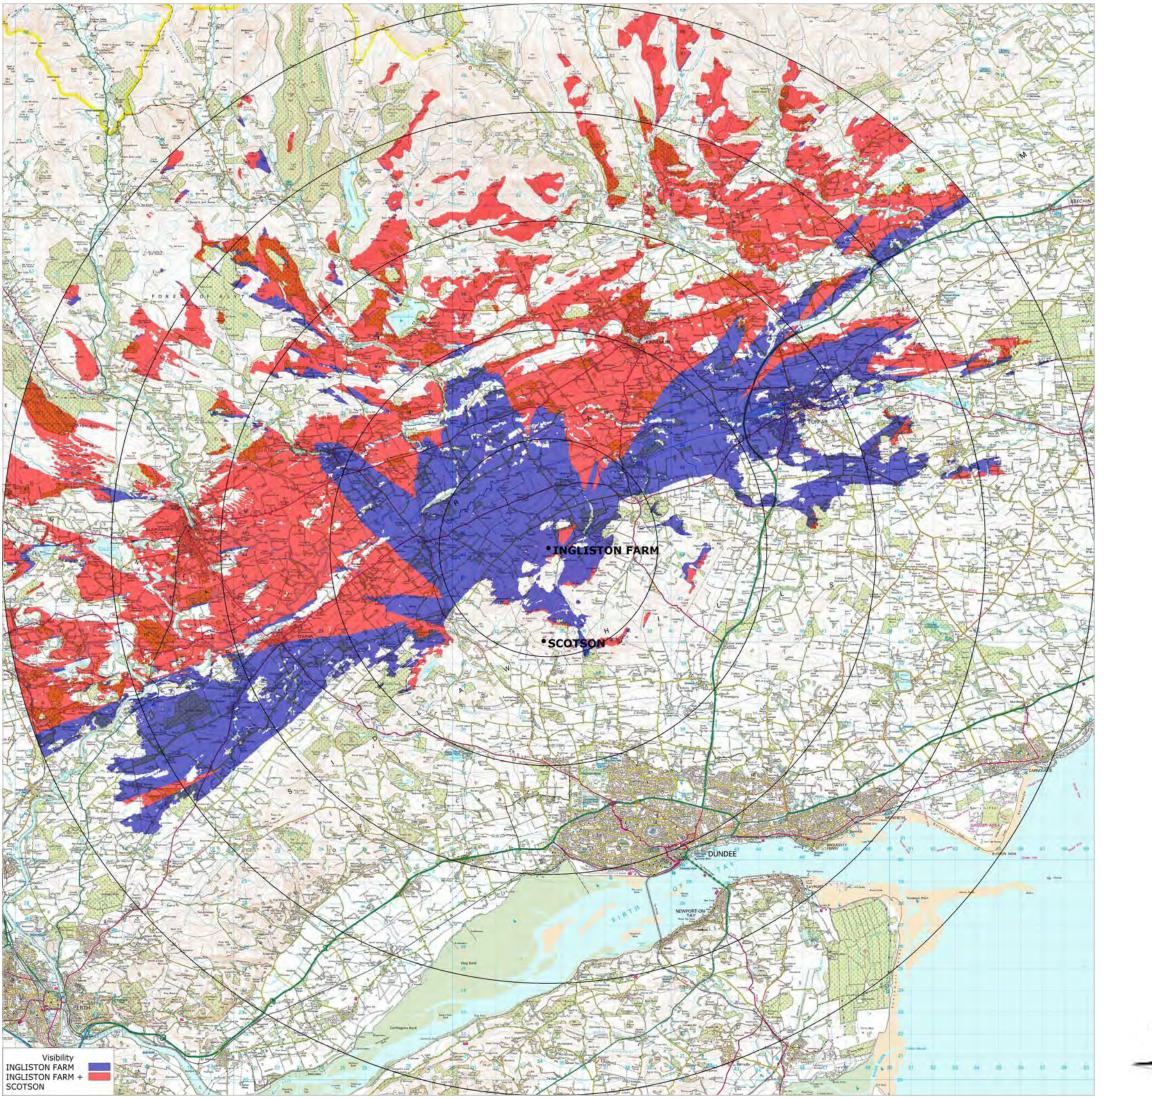Number of Turbines:	1
Turbine Model:	EWT Directwind 54
Hub Height:	50m
Blade diameter:	54m
Total height to blade tip:	77m
Turbine location:	334397 744313

Notes

This map shows the cumulative zone of visibility of the proposed Ingliston Farm turbine and the operational Scotson development.

Radii: 5, 10, 15, 20 and 25km

Legend

This theoretical visibility map is based on a receptor viewing height of 1.8m AGL. The levels of theoretical visibility are based on the following colouring scheme:

Blue: Only Ingliston Farm turbine visible


Red: At least the nacelle of the Ingliston Farm turbine and the Scotson turbine will be visible

Scotson details

No of turbines:	1
Distance from Ingliston Farm:	4.3km
Height to blade tip:	79.6m
Status:	Operational

PROJECT:	Ingliston Farm	
DRAWING TITLE:	Cumulative ZTV—Scotson	
DRAWING NO:	ING023	
DOCUMENT SIZE:	A3	
SCALE:	1:170,000	
DATE:	30/08/2013	
DRAWING BY:	Bojan Jevtic	
APPROVED BY:	Andy Lowe	

0	5	10

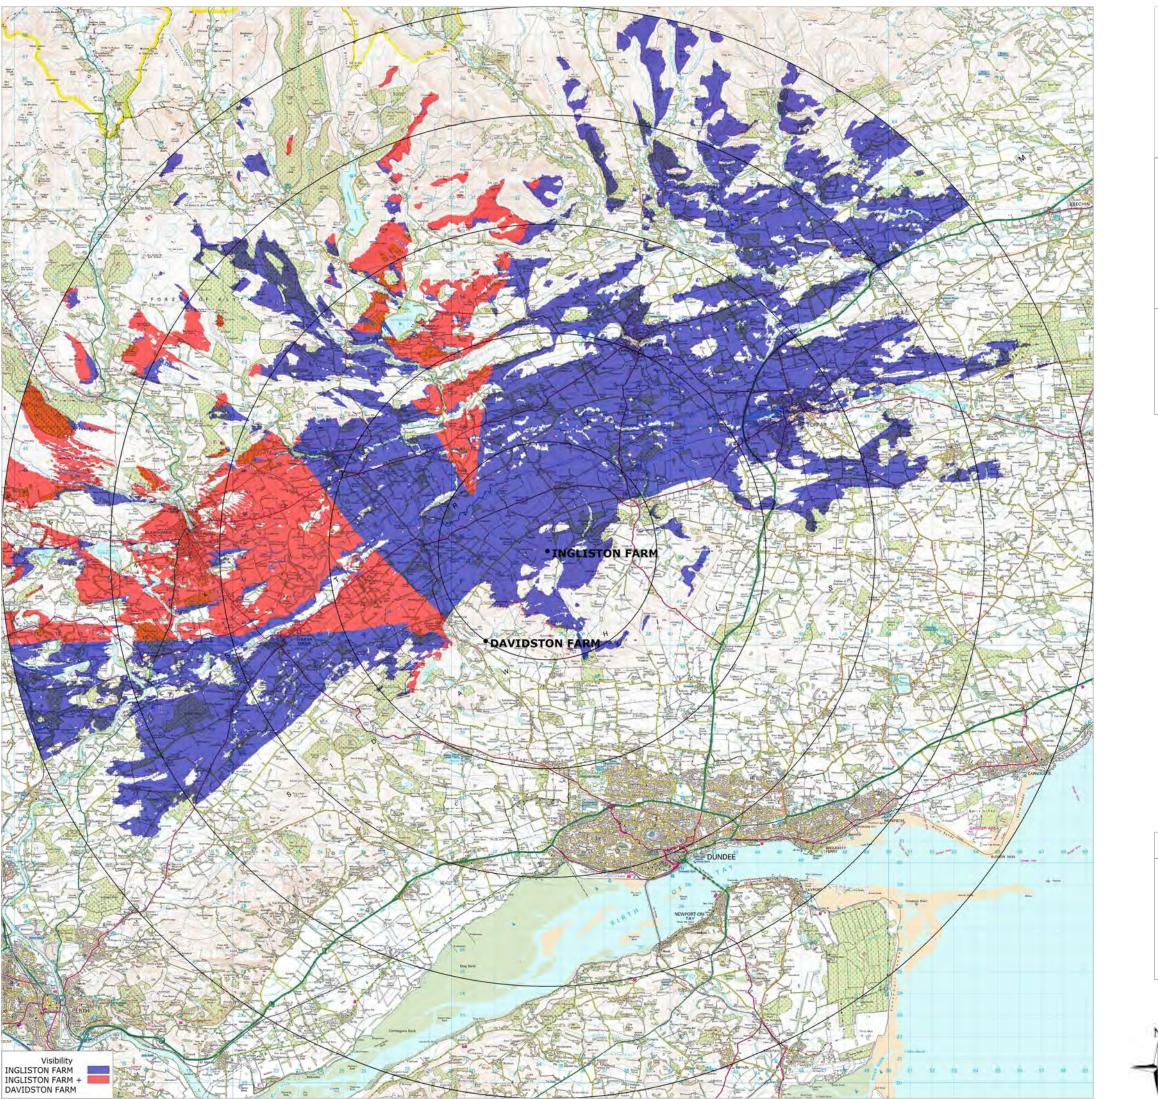

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Num

Turb Hub Blad Tota

Turb

This theoretical visibility map is based on a receptor viewing height of 1.8m AGL. The levels of theoretical visibility are based on the following colouring scheme:

Blue: Only Ingliston Farm turbine visible

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Project Description

nber of Turbines:	1
bine Model:	EWT Directwind 54
Height:	50m
de diameter:	54m
al height to blade tip:	77m
bine location:	334397 744313

Notes

This map shows the cumulative zone of visibility of the proposed Ingliston Farm turbine and the proposed Davidston Farm development.

Radii: 5, 10, 15, 20 and 25km

Legend


Red: At least the nacelle of the Ingliston Farm turbine and the Davidston Farm turbine will be visible

Davidston Farm details

of turbines:	1
tance from Ingliston Farm:	5.0km
ght to blade tip:	62.0m
tus:	Proposed
5	

OJECT:	Ingliston Farm
AWING TITLE:	Cumulative ZTV—Davidston Farm
AWING NO:	ING024
CUMENT SIZE:	A3
ALE:	1:170,000
TE:	30/08/2013
AWING BY:	Bojan Jevtic
PROVED BY:	Andy Lowe

0 5	

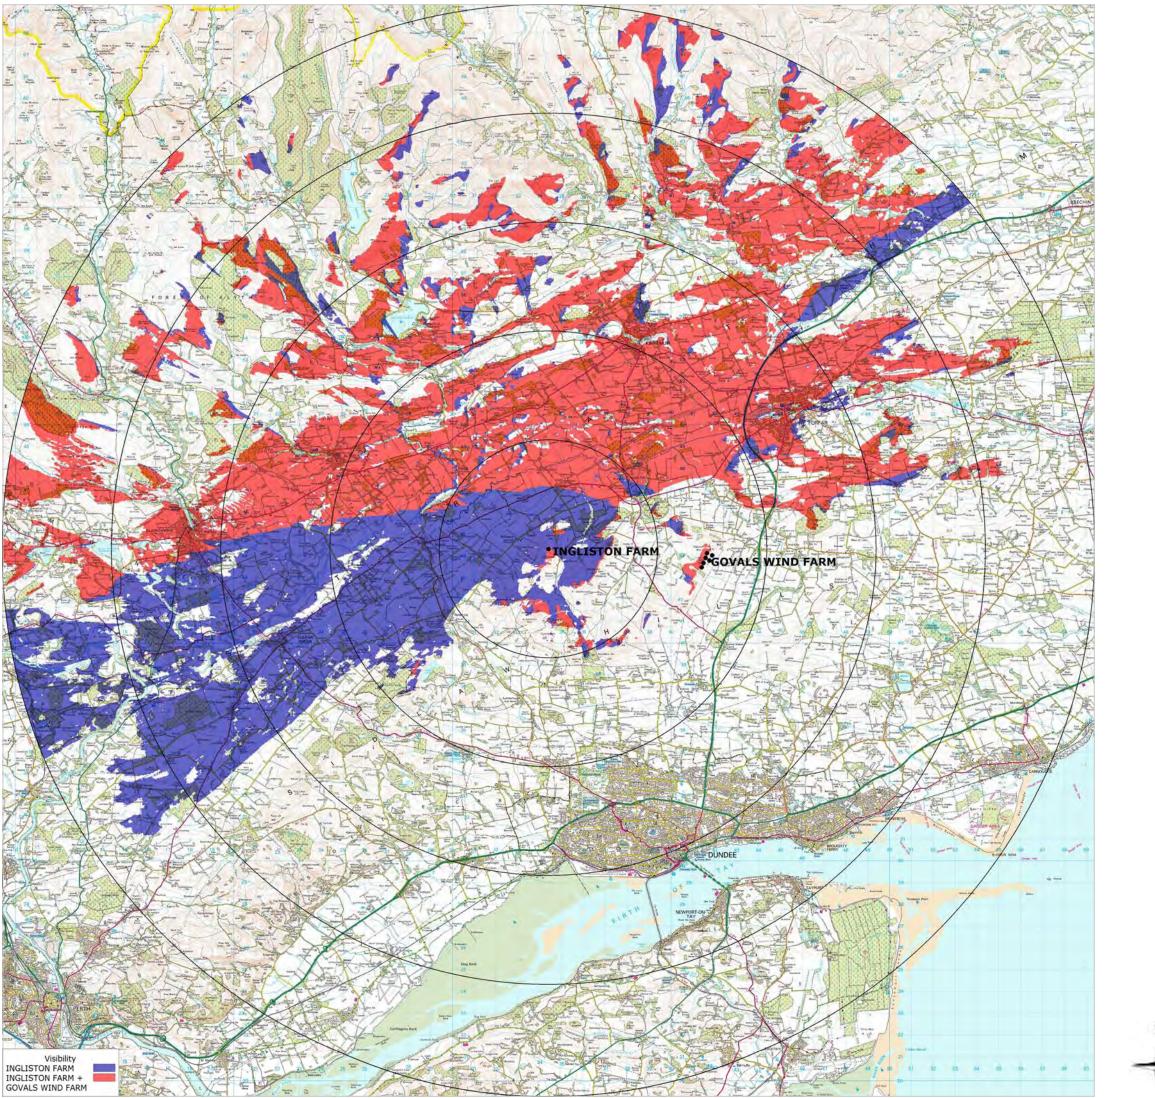

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Project Description

Number of Turbines:	1
Turbine Model:	EWT Directwind 54
Hub Height:	50m
Blade diameter:	54m
Total height to blade tip:	77m
Turbine location:	334397 744313

Notes

This map shows the cumulative zone of visibility of the proposed Ingliston Farm turbine and the proposed Govals development.

Radii: 5, 10, 15, 20 and 25km

Legend

No

This theoretical visibility map is based on a receptor viewing height of 1.8m AGL. The levels of theoretical visibility are based on the following colouring scheme:

Blue: Only Ingliston Farm turbine visible


Red: At least the nacelle of the Ingliston Farm turbine and the Govals Wind Farm turbines will be visible

Govals Wind Farm details

No of turbines:	6
Distance from Ingliston Farm:	7.1km
Height to blade tip:	86.5m
Status:	Proposed
Height to blade tip:	86.5m

PROJECT:	Ingliston Farm
DRAWING TITLE:	Cumulative ZTV—Govals Wind Farm
DRAWING NO:	ING025
DOCUMENT SIZE:	A3
SCALE:	1:170,000
DATE:	30/08/2013
DRAWING BY:	Bojan Jevtic
APPROVED BY:	Andy Lowe

0	5	10

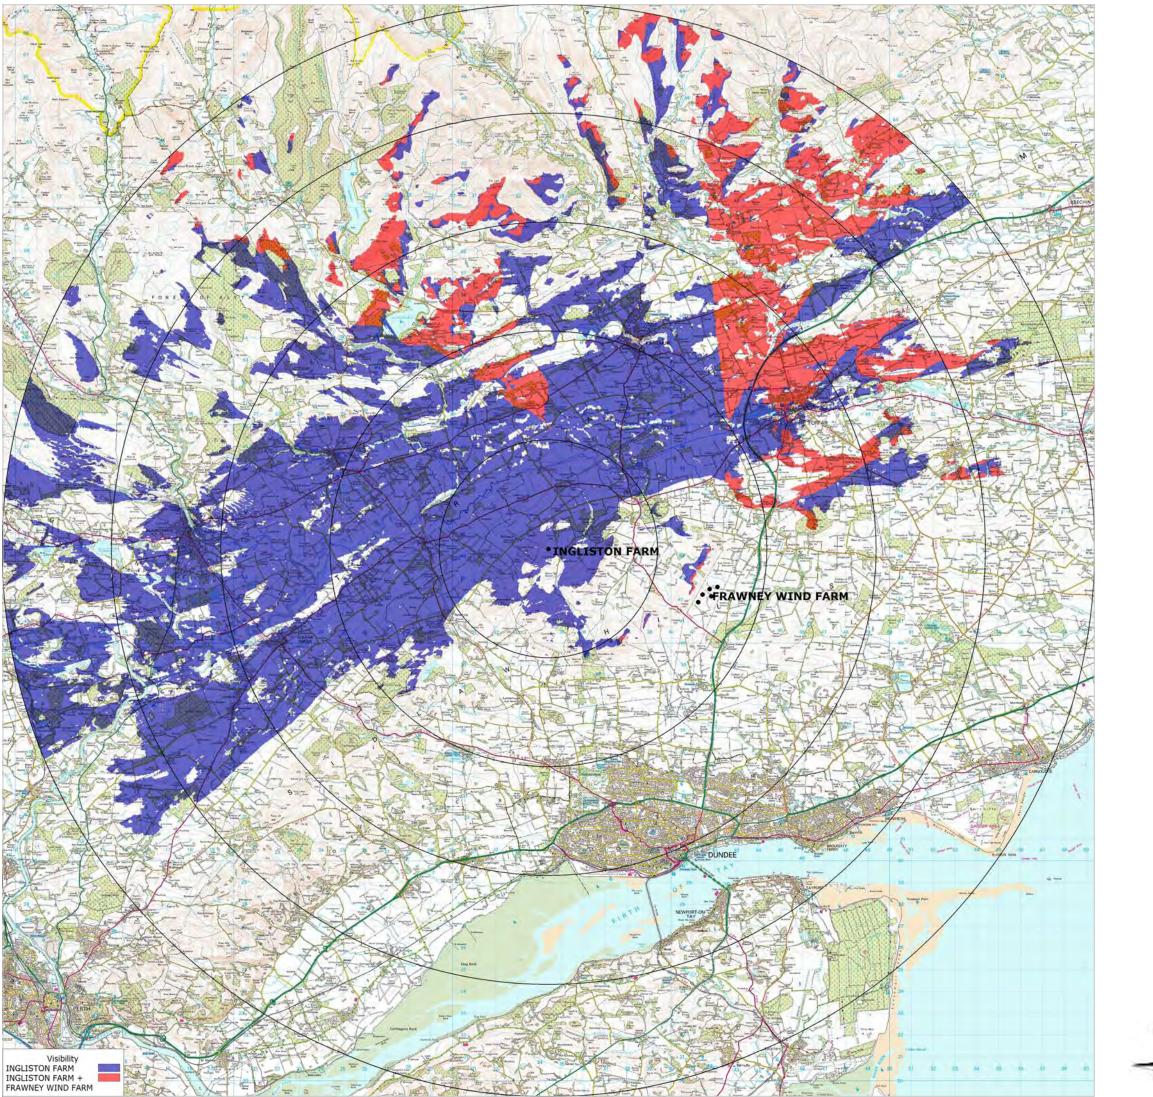

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Project Description

Number of Turbines:	1
Turbine Model:	EWT Directwind 54
Hub Height:	50m
Blade diameter:	54m
Total height to blade tip:	77m
Turbine location:	334397 744313

Notes

This map shows the cumulative zone of visibility of the proposed Ingliston Farm turbine and the proposed Frawney development.

Radii: 5, 10, 15, 20 and 25km

Legend

This theoretical visibility map is based on a receptor viewing height of 1.8m AGL. The levels of theoretical visibility are based on the following colouring scheme:

Blue: Only Ingliston Farm turbine visible


Red: At least the nacelle of the Ingliston Farm turbine and the Frawney Wind Farm turbines will be visible

Frawney Wind Farm details

No of turbines:	5
Distance from Ingliston Farm:	7.3km
Height to blade tip:	80.0m
Status:	Proposed

PROJECT:	Ingliston Farm
DRAWING TITLE:	Cumulative ZTV—Frawney Wind Farm
DRAWING NO:	ING026
DOCUMENT SIZE:	A3
SCALE:	1:170,000
DATE:	30/08/2013
DRAWING BY:	Bojan Jevtic
APPROVED BY:	Andy Lowe

0	5	10	15km

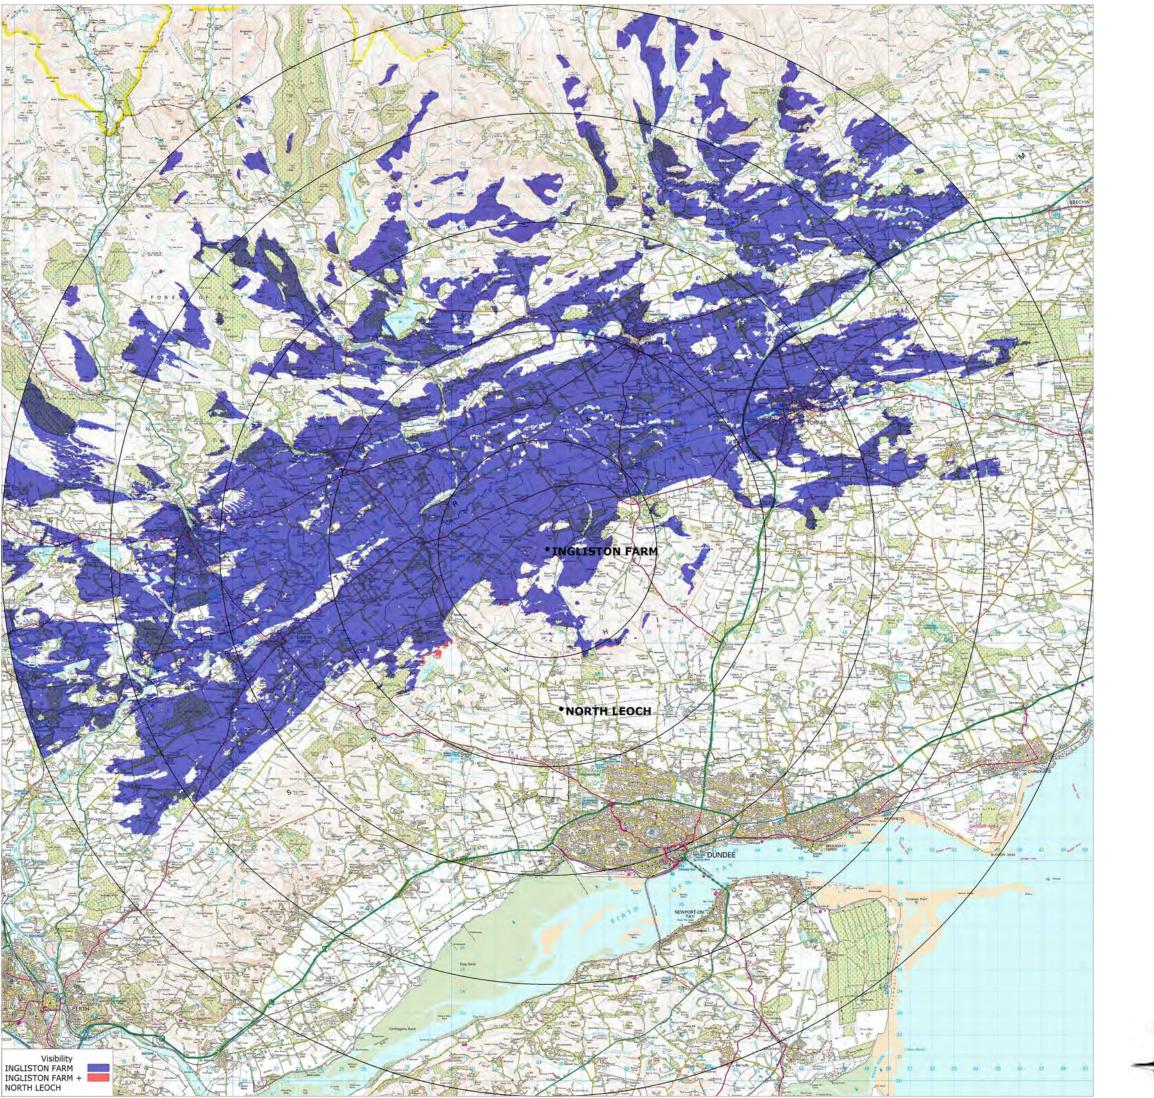

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Num

Turb Hub Blad Tota

Turb

This map shows the cumulative zone of visibility of the proposed Ingliston Farm turbine and the approved North Leoch development.

Radii: 5, 10, 15, 20 and 25km

This theoretical visibility map is based on a receptor viewing height of 1.8m AGL. The levels of theoretical visibility are based on the following colouring scheme:

Blue: Only Ingliston Farm turbine visible

No

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Project Description

nber of Turbines:	1
bine Model:	EWT Directwind 54
Height:	50m
de diameter:	54m
al height to blade tip:	77m
bine location:	334397 744313

Notes

Legend


Red: At least the nacelle of the Ingliston Farm turbine and the North Leoch turbine will be visible

North Leoch details

1
7.4km
45.6m
Approved

OJECT:	Ingliston Farm
AWING TITLE:	Cumulative ZTV—North Leoch
AWING NO:	ING027
CUMENT SIZE:	A3
ALE:	1:170,000
TE:	30/08/2013
AWING BY:	Bojan Jevtic
PROVED BY:	Andy Lowe

0	5	10

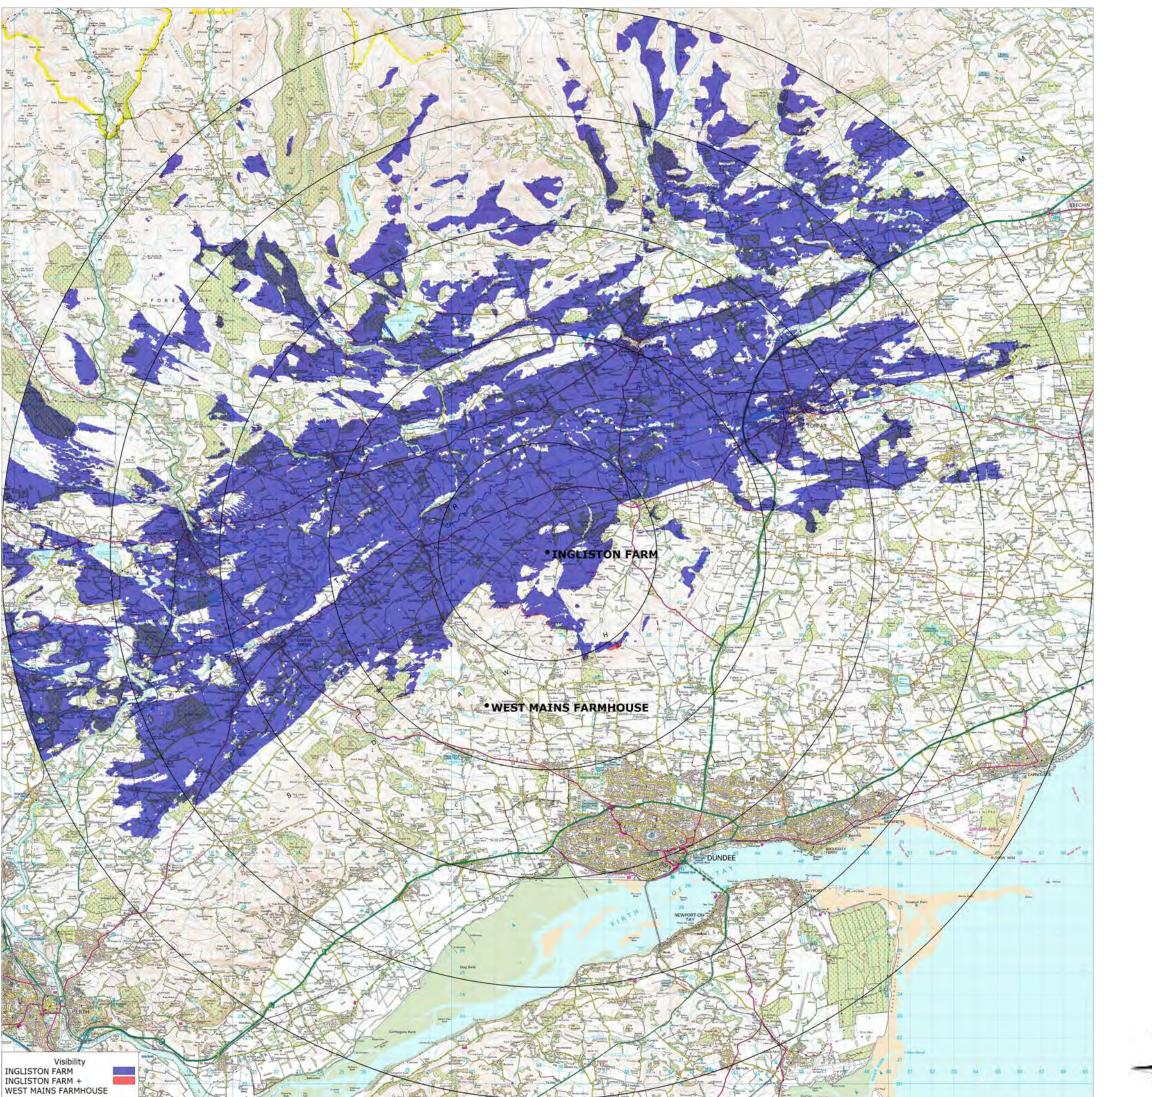

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ment.

Blue: Only Ingliston Farm turbine visible

No Dist

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Project Description

Number of Turbines:	1
Turbine Model:	EWT Directwind 54
Hub Height:	50m
Blade diameter:	54m
Total height to blade tip:	77m
Turbine location:	334397 744313

Notes

This map shows the cumulative zone of visibility of the proposed Ingliston Farm turbine and the approved West Mains Farmhouse develop-

Radii: 5, 10, 15, 20 and 25km

Legend

This theoretical visibility map is based on a receptor viewing height of 1.8m AGL. The levels of theoretical visibility are based on the following colouring scheme:


Red: At least the nacelle of the Ingliston Farm turbine and the West Mains Farmhouse turbine will be visible

West Mains Farmhouse details

of turbines:	1
tance from Ingliston Farm:	7.6km
ght to blade tip:	61.0m
tus:	Approved

OJECT:	Ingliston Farm
AWING TITLE:	Cumulative ZTV—West Mains Farmhouse
AWING NO:	ING028
CUMENT SIZE:	A3
ALE:	1:170,000
TE:	30/08/2013
AWING BY:	Bojan Jevtic
PROVED BY:	Andy Lowe

0	5	10	15km

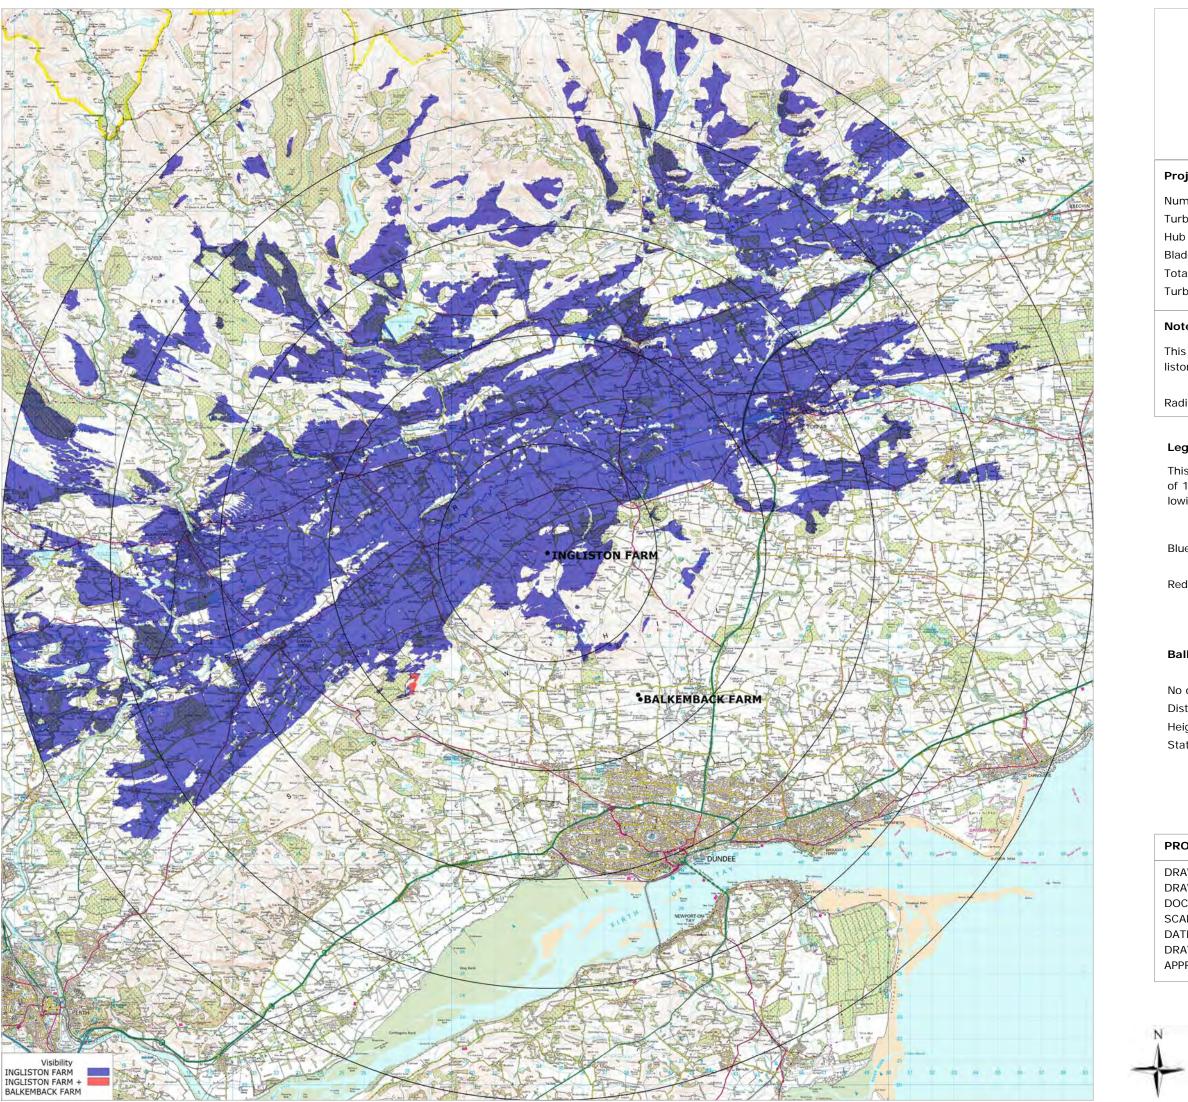

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No



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Project Description

Number of Turbines:	1
Turbine Model:	EWT Directwind 54
Hub Height:	50m
Blade diameter:	54m
Total height to blade tip:	77m
Turbine location:	334397 744313

Notes

This map shows the cumulative zone of visibility of the proposed Ingliston Farm turbine and the approved Balkemback Farm development.

Radii: 5, 10, 15, 20 and 25km

Legend

This theoretical visibility map is based on a receptor viewing height of 1.8m AGL. The levels of theoretical visibility are based on the following colouring scheme:

Blue: Only Ingliston Farm turbine visible


Red: At least the nacelle of the Ingliston Farm turbine and the Balkemback Farm turbines will be visible

Balkemback Farm details

2
7.7km
46.5m
Approved

PROJECT:	Ingliston Farm
DRAWING TITLE:	Cumulative ZTV—Balkemback Farm
DRAWING NO:	ING029
DOCUMENT SIZE:	A3
SCALE:	1:170,000
DATE:	30/08/2013
DRAWING BY:	Bojan Jevtic
APPROVED BY:	Andy Lowe

0	5	10

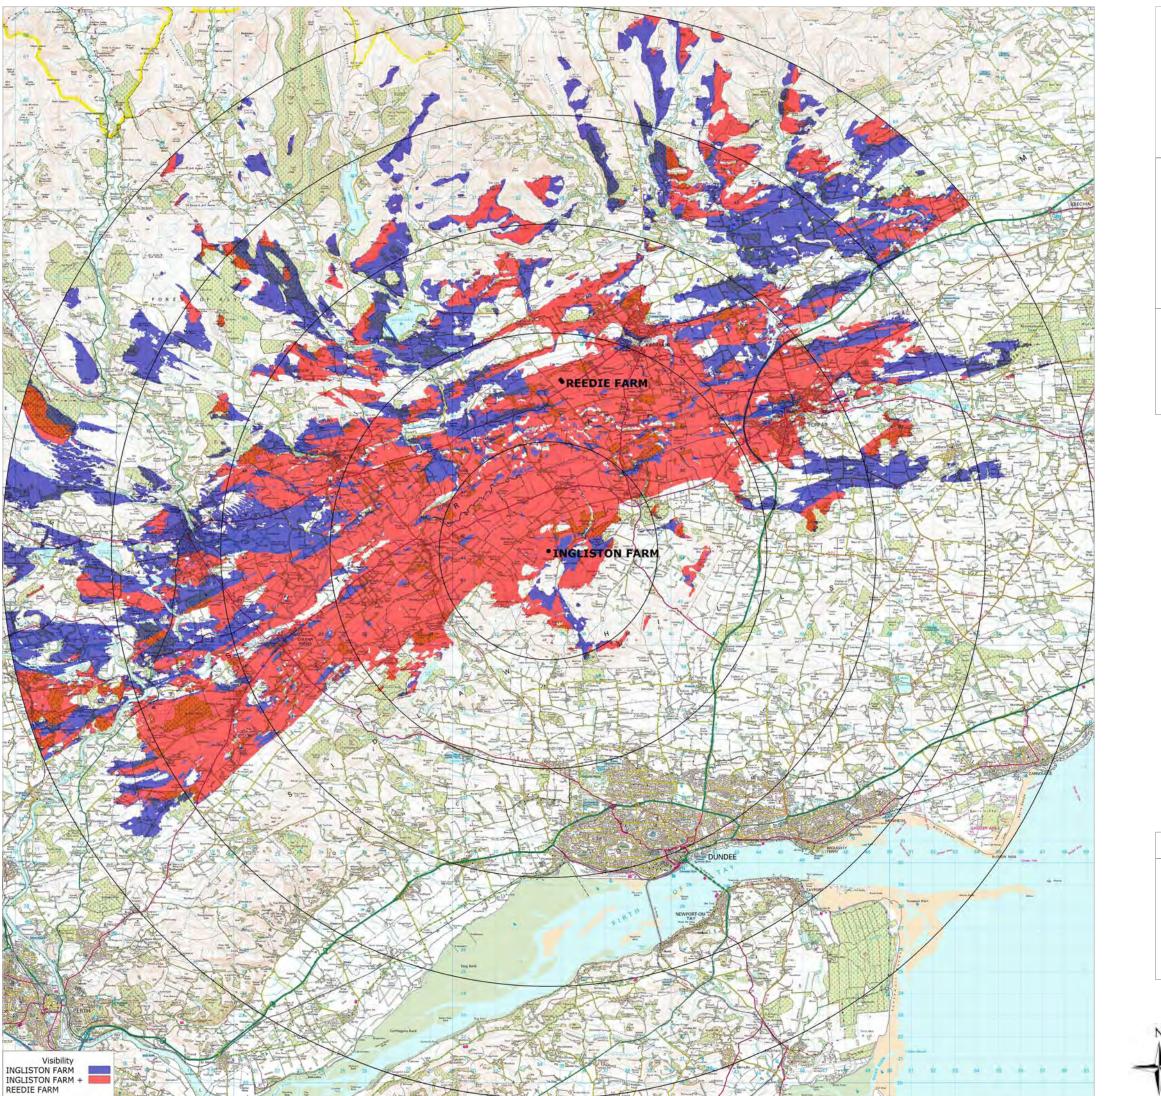

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Map

Num

Turb Hub Blad Tota

Turb

This map shows the cumulative zone of visibility of the proposed Ingliston Farm turbine and the approved Reedie Farm development.

Radii: 5, 10, 15, 20 and 25km

Legend

This theoretical visibility map is based on a receptor viewing height of 1.8m AGL. The levels of theoretical visibility are based on the following colouring scheme:

Blue: Only Ingliston Farm turbine visible

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Project Description

nber of Turbines:	1
bine Model:	EWT Directwind 54
Height:	50m
de diameter:	54m
al height to blade tip:	77m
bine location:	334397 744313

Notes


Red: At least the nacelle of the Ingliston Farm turbine and the Reedie Farm turbines will be visible

Reedie Farm details

of turbines:	2
tance from Ingliston Farm:	7.8km
ght to blade tip:	46.9m
tus:	Approved

OJECT:	Ingliston Farm
AWING TITLE:	Cumulative ZTV—Reedie Farm
AWING NO:	ING030
CUMENT SIZE:	A3
ALE:	1:170,000
TE:	30/08/2013
AWING BY:	Bojan Jevtic
PROVED BY:	Andy Lowe

0	5	10

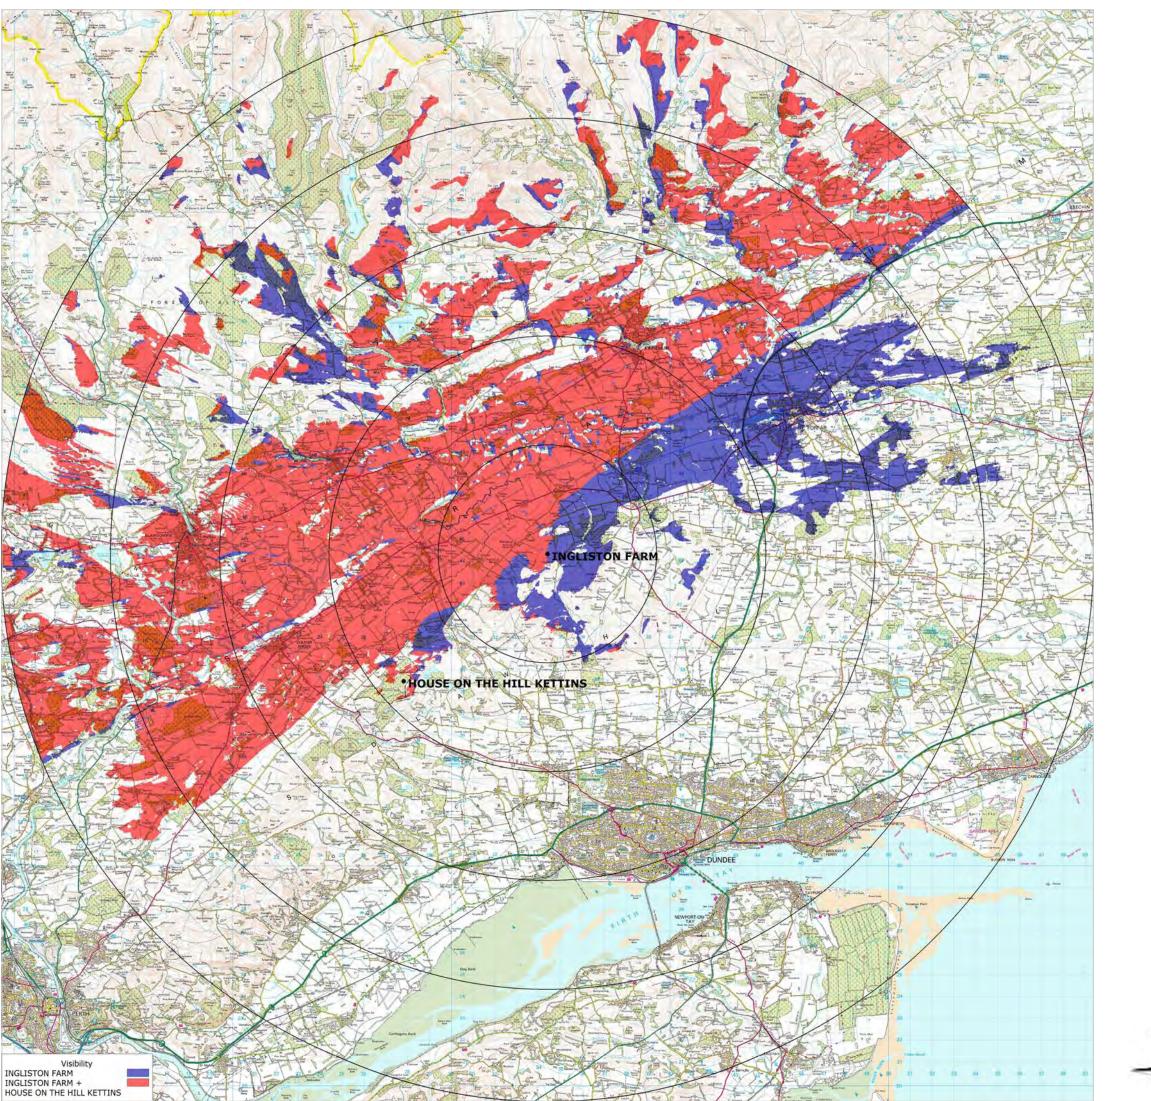

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Tota Turb

This map shows the cumulative zone of visibility of the proposed Ing-

liston Farm turbine and the approved House On The Hill Kettins development. Radii: 5, 10, 15, 20 and 25km

This theoretical visibility map is based on a receptor viewing height of 1.8m AGL. The levels of theoretical visibility are based on the following colouring scheme:

Blue: Only Ingliston Farm turbine visible

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Project Description

Number of Turbines:	1
Turbine Model:	EWT Directwind 54
Hub Height:	50m
Blade diameter:	54m
Total height to blade tip:	77m
Turbine location:	334397 744313

Notes

Legend


Red: At least the nacelle of the Ingliston Farm turbine and the House On The Hill Kettins turbine will be visible

House On The Hill Kettins details

of turbines:	1
tance from Ingliston Farm:	8.8km
ght to blade tip:	45.4m
tus:	Approved

Ingliston Farm
Cumulative ZTV—House On The Hill
Kettins
ING031
A3
1:170,000
30/08/2013
Bojan Jevtic
Andy Lowe

0	5	10	15km
1			

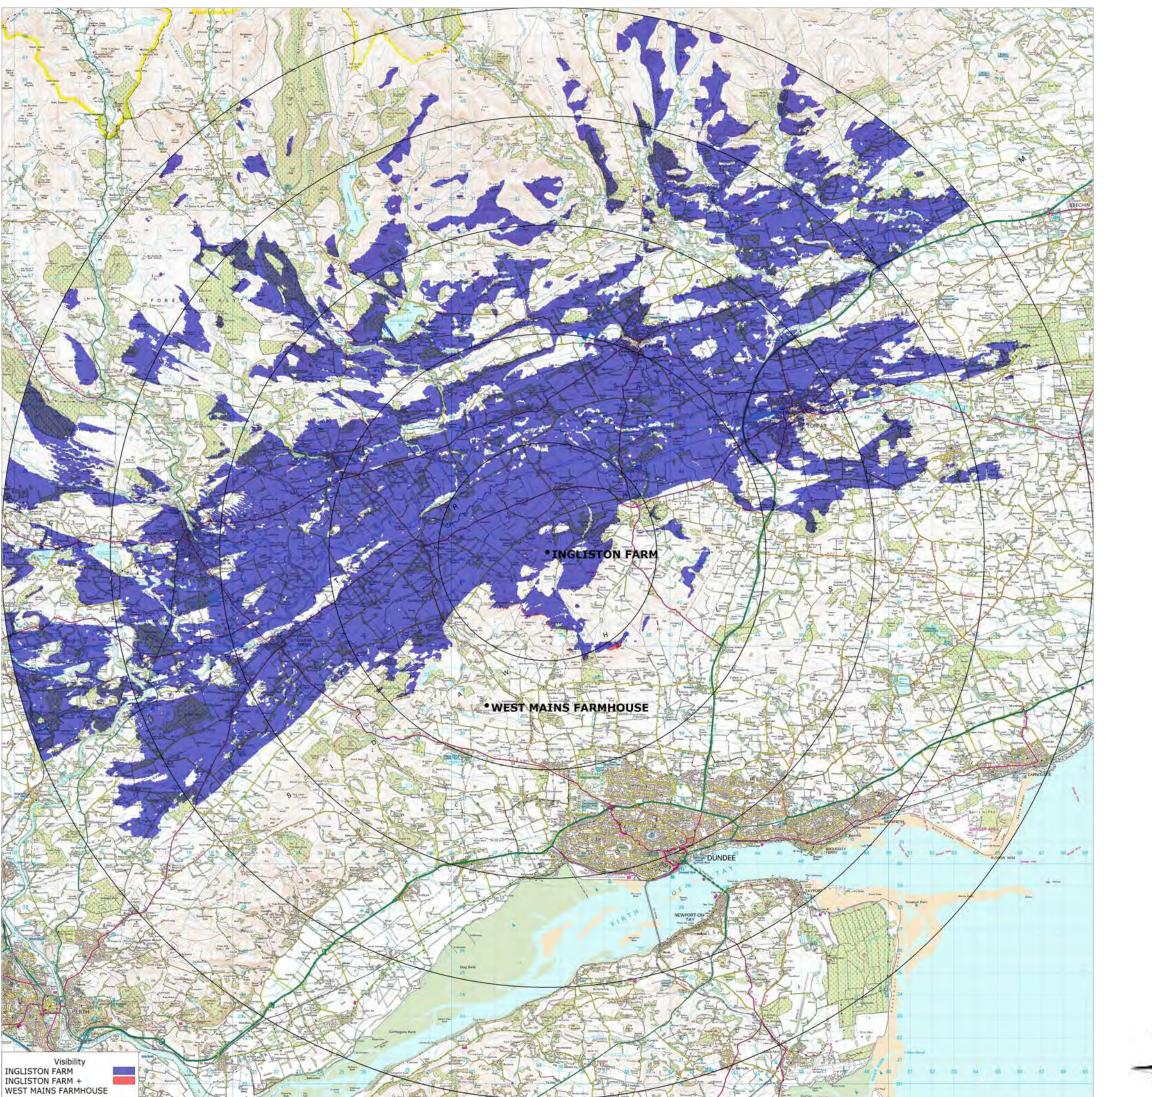

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Num Turb Hub

Blad Tota Turb

Notes

This map shows the cumulative zone of visibility of the proposed Ingliston Farm turbine and the operational West Adamston Farm development. Radii: 5, 10, 15, 20 and 25km

This theoretical visibility map is based on a receptor viewing height of 1.8m AGL. The levels of theoretical visibility are based on the following colouring scheme:

Blue: Only Ingliston Farm turbine visible

No Dist Heig Stat

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Locogen Ltd, 44 Constitution St, Edinburgh, EH6 6RS Tel: +44 (0) 131 555 4745; Email: info@locogen.com Company Number: SC370060; VAT Number: 983 3836 77

Project Description

nber of Turbines:	1
bine Model:	EWT Directwind 54
Height:	50m
de diameter:	54m
al height to blade tip:	77m
bine location:	334397 744313

Legend


Red: At least the nacelle of the Ingliston Farm turbine and the West Adamston Farm turbine will be visible

West Adamston Farm details

of turbines:	1
tance from Ingliston Farm:	8.9km
ght to blade tip:	47.5m
itus:	Operational

OJECT:	Ingliston Farm
AWING TITLE:	Cumulative ZTV—West Adamston Farm
AWING NO:	ING032
CUMENT SIZE:	A3
ALE:	1:170,000
TE:	30/08/2013
AWING BY:	Bojan Jevtic
ROVED BY:	Andy Lowe

0	5	10	15km

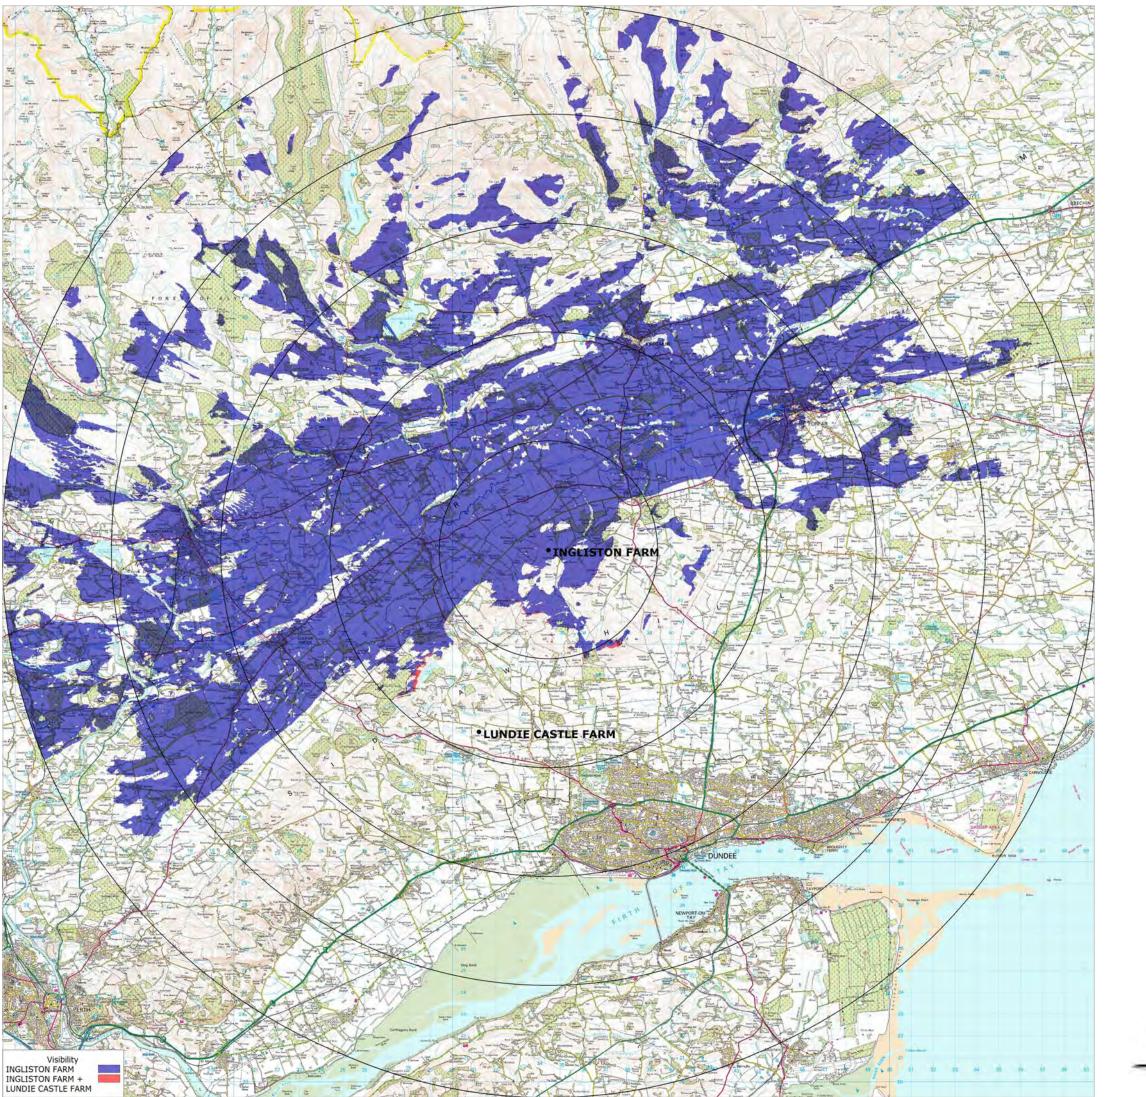

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Num Turb

Hub Blad Tota

Turb Notes

This map shows the cumulative zone of visibility of the proposed Ingliston Farm turbine and the proposed Lundie Castle Farm development. Radii: 5, 10, 15, 20 and 25km

This theoretical visibility map is based on a receptor viewing height of 1.8m AGL. The levels of theoretical visibility are based on the following colouring scheme:

Blue: Only Ingliston Farm turbine visible

No Dista Heig Stat

PRO DRA\ DRA DOC SCA DATI DRA APPF



Locogen Ltd, 44 Constitution St, Edinburgh, EH6 6RS Tel: +44 (0) 131 555 4745; Email: info@locogen.com Company Number: SC370060; VAT Number: 983 3836 77

Project Description

nber of Turbines:	1
bine Model:	EWT Directwind 54
Height:	50m
de diameter:	54m
al height to blade tip:	77m
bine location:	334397 744313

Legend


Red: At least the nacelle of the Ingliston Farm turbine and the Lundie Castle Farm turbine will be visible

Lundie Castle Farm details

of turbines:	1
tance from Ingliston Farm:	8.9km
ght to blade tip:	48.5m
tus:	Proposed

OJECT:	Ingliston Farm
AWING TITLE:	Cumulative ZTV—Lundie Castle Farm
AWING NO:	ING033
CUMENT SIZE:	A3
ALE:	1:170,000
TE:	30/08/2013
AWING BY:	Bojan Jevtic
PROVED BY:	Andy Lowe

0	5	10

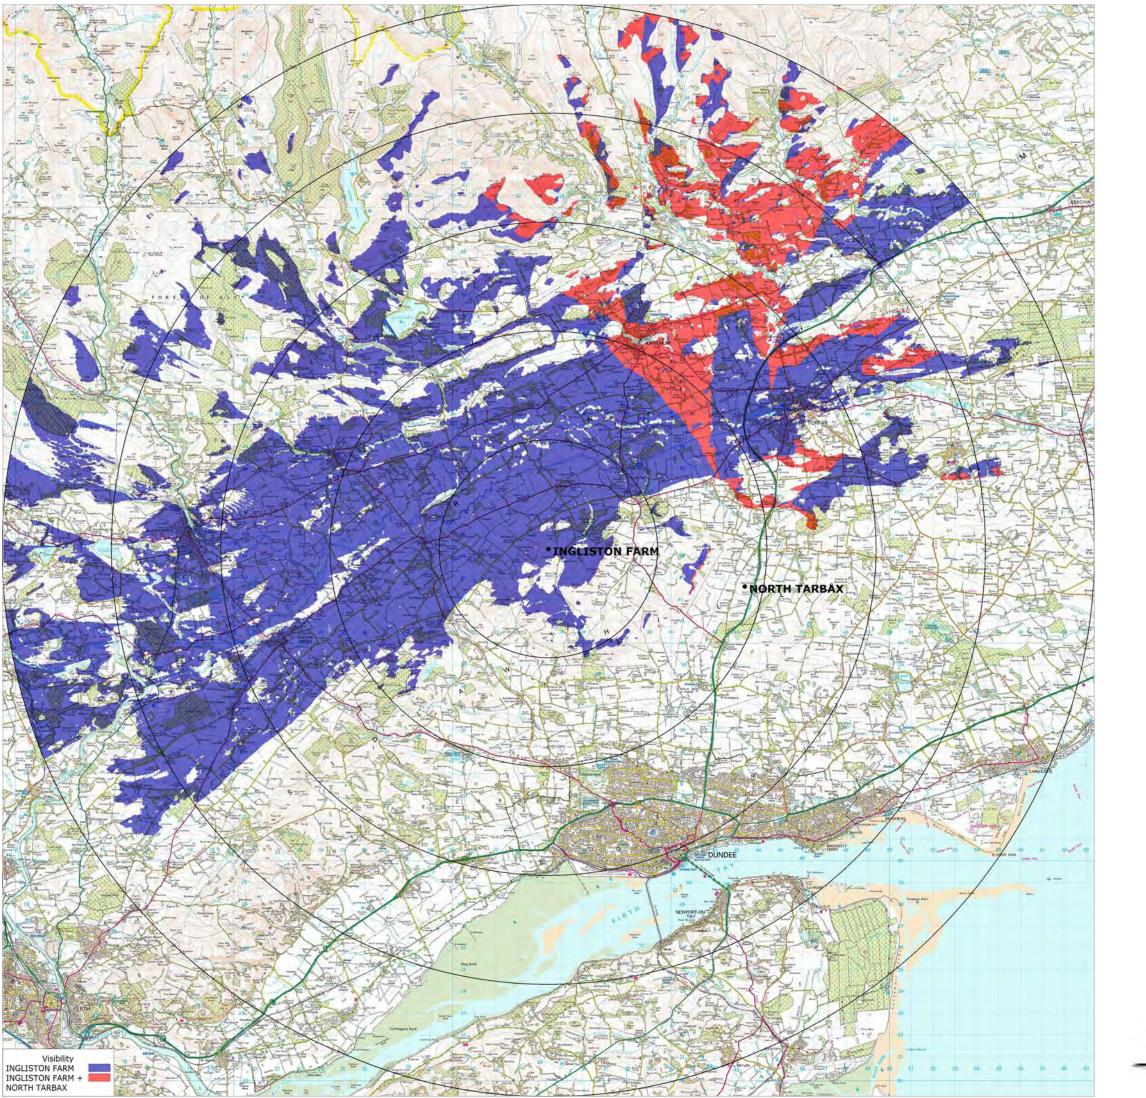

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Notes

This map shows the cumulative zone of visibility of the proposed Ingliston Farm turbine and the approved North Tarbax development.

Radii: 5, 10, 15, 20 and 25km

This theoretical visibility map is based on a receptor viewing height of 1.8m AGL. The levels of theoretical visibility are based on the following colouring scheme:

Blue: Only Ingliston Farm turbine visible

No Dista Heig Stat

PRO DRA\ DRA\ DOC SCA DATI DRA\ APPF



Locogen Ltd, 44 Constitution St, Edinburgh, EH6 6RS Tel: +44 (0) 131 555 4745; Email: info@locogen.com Company Number: SC370060; VAT Number: 983 3836 77

Project Description

Number of Turbines:	1
Turbine Model:	EWT Directwind 54
Hub Height:	50m
Blade diameter:	54m
Total height to blade tip:	77m
Turbine location:	334397 744313

Legend


Red: At least the nacelle of the Ingliston Farm turbine and the North Tarbax turbine will be visible

North Tarbax details

of turbines:	1
tance from Ingliston Farm:	9.1km
ght to blade tip:	45.9m
tus:	Approved

OJECT:	Ingliston Farm
AWING TITLE:	Cumulative ZTV—North Tarbax
AWING NO:	ING034
CUMENT SIZE:	A3
ALE:	1:170,000
TE:	30/08/2013
AWING BY:	Bojan Jevtic
PROVED BY:	Andy Lowe

0	5	10	

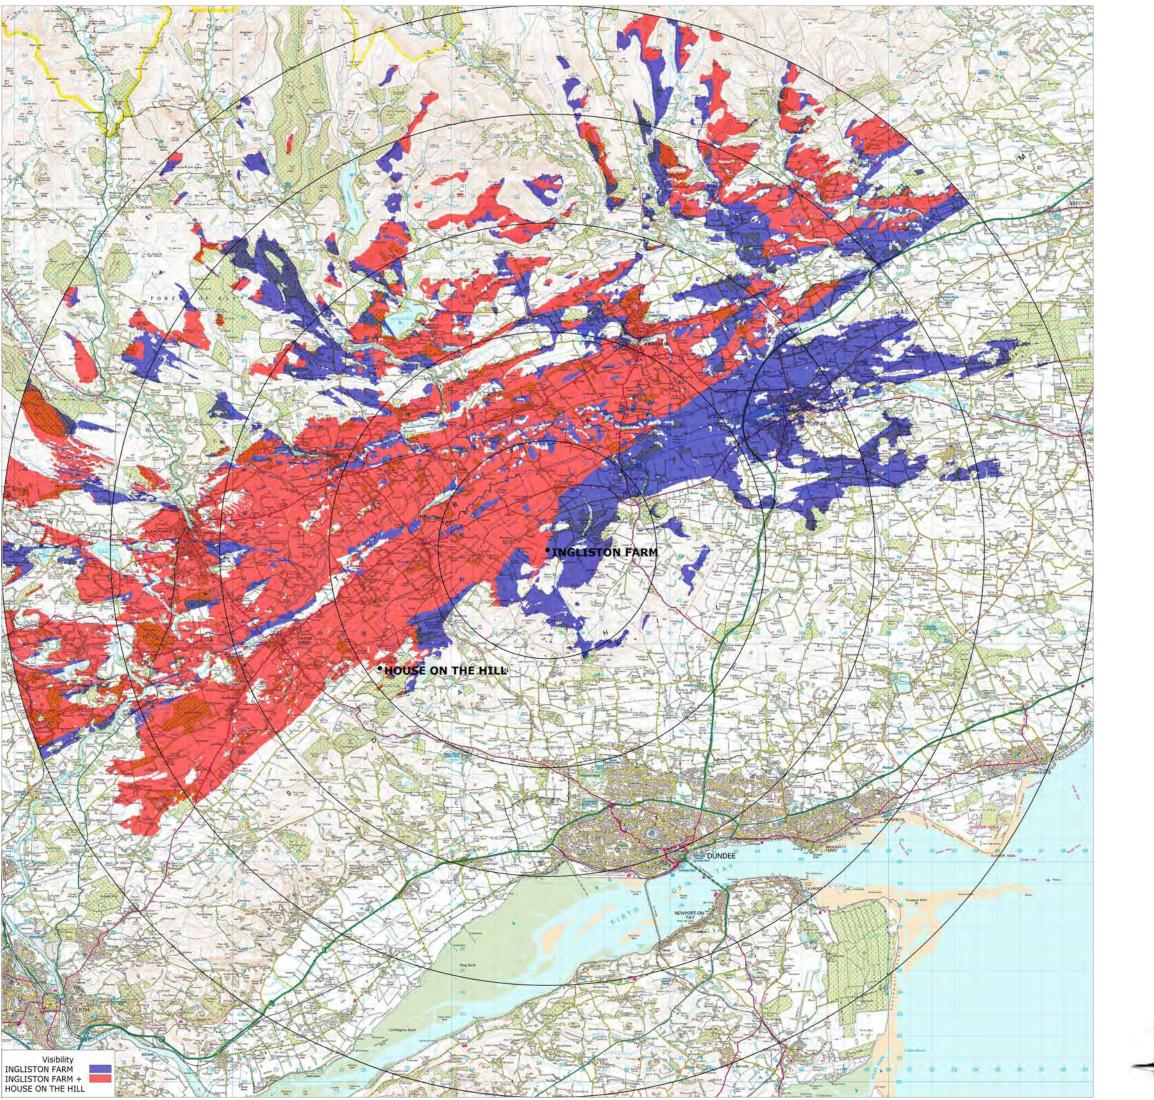

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Num

Turb Hub Blad Tota

Turb

This map shows the cumulative zone of visibility of the proposed Ingliston Farm turbine and the approved House On The Hill development.

Radii: 5, 10, 15, 20 and 25km

This theoretical visibility map is based on a receptor viewing height of 1.8m AGL. The levels of theoretical visibility are based on the following colouring scheme:

Blue: Only Ingliston Farm turbine visible

No Dist Heig Stat

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Locogen Ltd, 44 Constitution St, Edinburgh, EH6 6RS Tel: +44 (0) 131 555 4745; Email: info@locogen.com Company Number: SC370060; VAT Number: 983 3836 77

Project Description

nber of Turbines:	1
bine Model:	EWT Directwind 54
Height:	50m
de diameter:	54m
al height to blade tip:	77m
bine location:	334397 744313

Notes

Legend


Red: At least the nacelle of the Ingliston Farm turbine and the House On The Hill turbine will be visible

House On The Hill details

of turbines:	1
tance from Ingliston Farm:	9.4km
ght to blade tip:	46.5m
tus:	Approved

OJECT:	Ingliston Farm
AWING TITLE:	Cumulative ZTV—House On The Hill
AWING NO:	ING035
CUMENT SIZE:	A3
ALE:	1:170,000
TE:	30/08/2013
AWING BY:	Bojan Jevtic
PROVED BY:	Andy Lowe

0	5	10

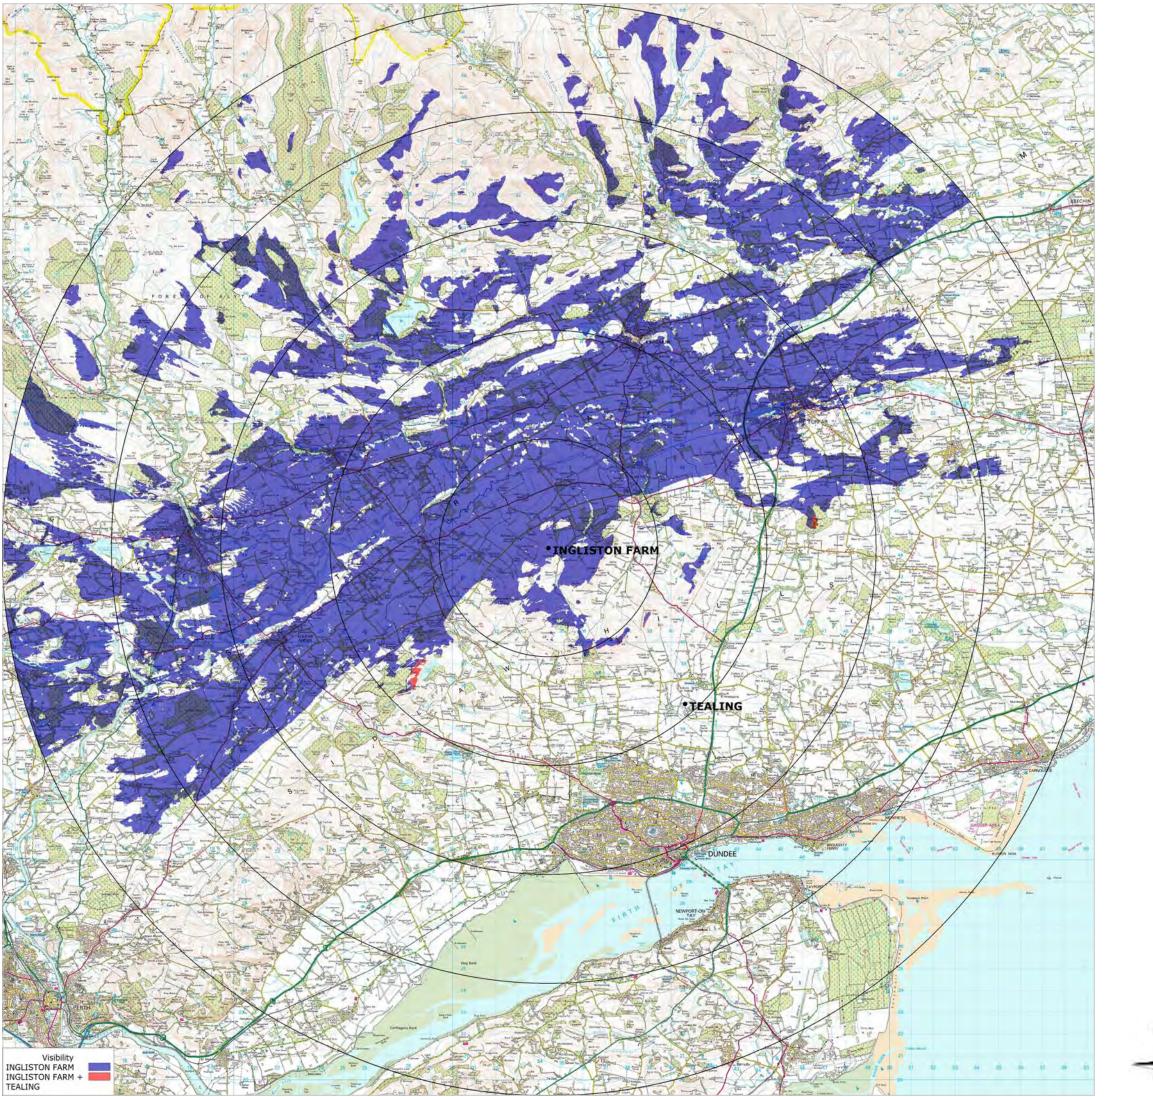

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Num Turb

Hub Blad Tota

Turb

This map shows the cumulative zone of visibility of the proposed Ingliston Farm turbine and the approved Tealing development.

Radii: 5, 10, 15, 20 and 25km

This theoretical visibility map is based on a receptor viewing height of 1.8m AGL. The levels of theoretical visibility are based on the following colouring scheme:

Blue: Only Ingliston Farm turbine visible

No Dist Heig Stat

PRO DRA\ DRA\ DOC SCAL DATE DRA\ APPR



Locogen Ltd, 44 Constitution St, Edinburgh, EH6 6RS Tel: +44 (0) 131 555 4745; Email: info@locogen.com Company Number: SC370060; VAT Number: 983 3836 77

Project Description

nber of Turbines:	1
bine Model:	EWT Directwind 54
Height:	50m
de diameter:	54m
al height to blade tip:	77m
bine location:	334397 744313

Notes

Legend


Red: At least the nacelle of the Ingliston Farm turbine and the Tealing turbine will be visible

Tealing details

of turbines:	1
tance from Ingliston Farm:	9.5km
ght to blade tip:	86.5m
tus:	Approved

OJECT:	Ingliston Farm
AWING TITLE:	Cumulative ZTV—Tealing
AWING NO:	ING036
CUMENT SIZE:	A3
ALE:	1:170,000
ΓE:	30/08/2013
AWING BY:	Bojan Jevtic
PROVED BY:	Andy Lowe

0	5	10

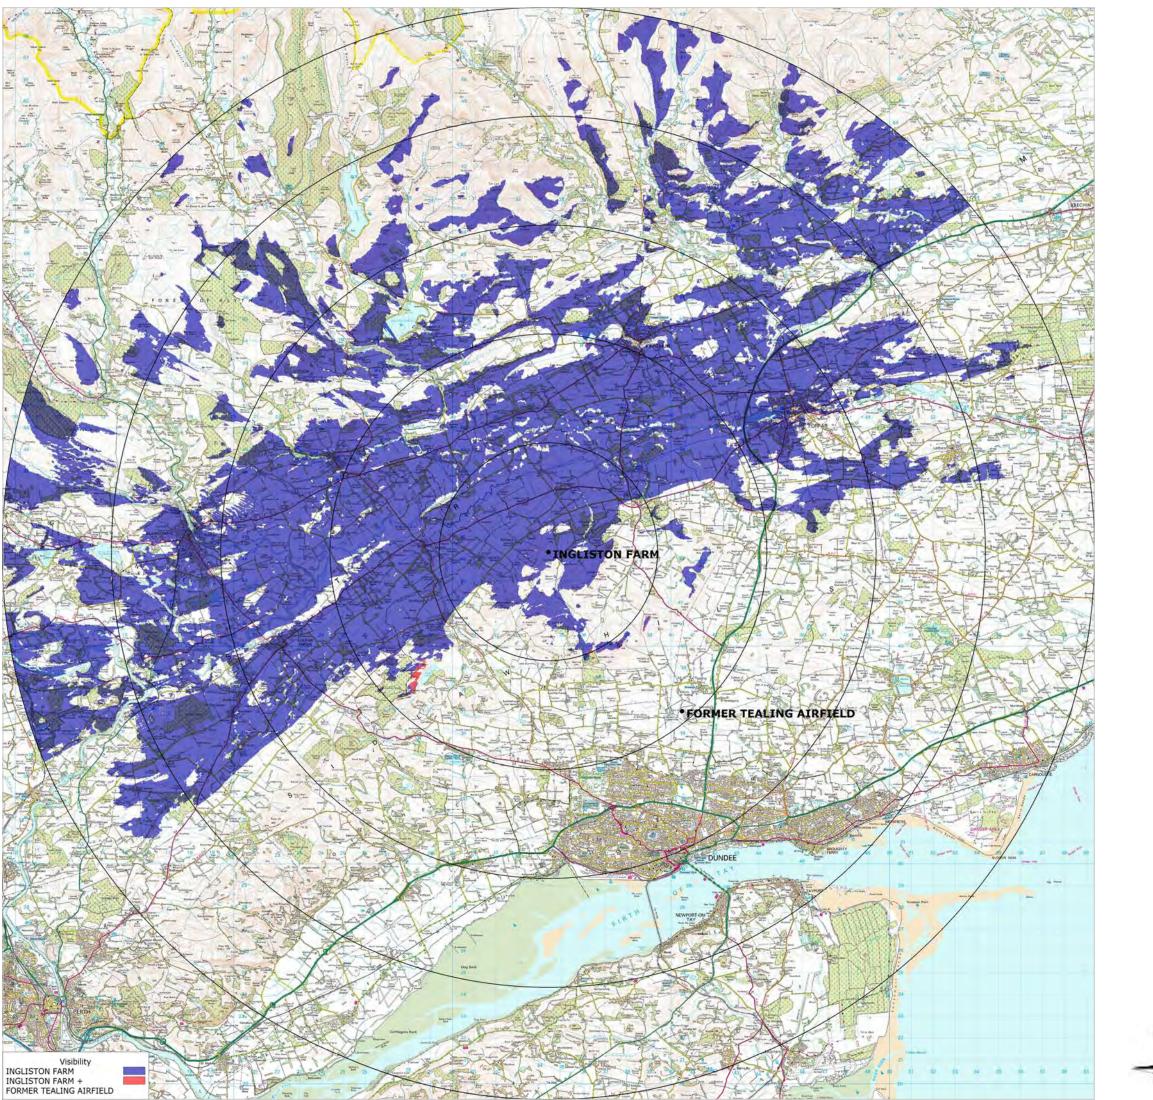

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Project Description

Number of Turbines:	1
Turbine Model:	EWT Directwind 54
Hub Height:	50m
Blade diameter:	54m
Total height to blade tip:	77m
Turbine location:	334397 744313

Notes

This map shows the cumulative zone of visibility of the proposed Ingliston Farm turbine and the proposed Former Tealing Airfield development.

Legend

This theoretical visibility map is based on a receptor viewing height of 1.8m AGL. The levels of theoretical visibility are based on the following colouring scheme:


- Blue: Only Ingliston Farm turbine visible
- Red: At least the nacelle of the Ingliston Farm turbine and the Former Tealing Airfield turbine will be visible

Former Tealing Airfield details

No of turbines:	1
Distance from Ingliston Farm:	9.5km
Height to blade tip:	86.5m
Status:	Proposed

PROJECT:	Ingliston Farm
DRAWING TITLE:	Cumulative ZTV—Former Tealing Airfield
DRAWING NO:	ING037
DOCUMENT SIZE:	A3
SCALE:	1:170,000
DATE:	30/08/2013
DRAWING BY:	Bojan Jevtic
APPROVED BY:	Andy Lowe

0	5	10	15km

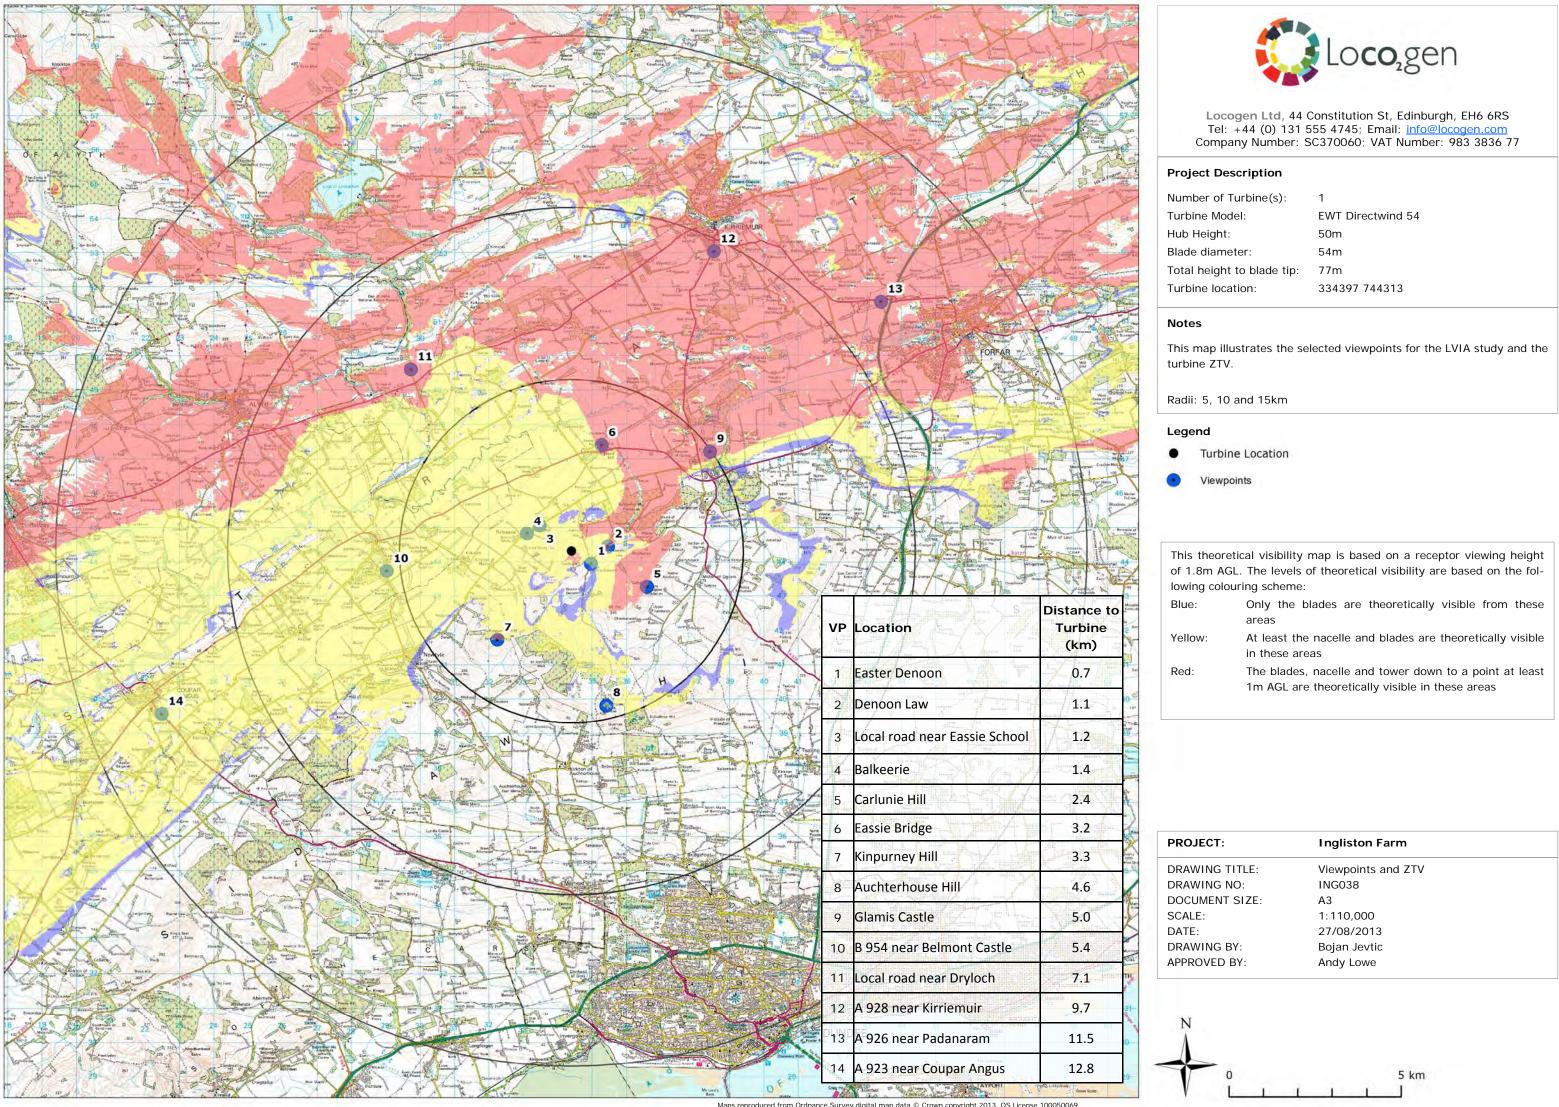

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nber of Turbine(s):	1	
bine Model:	EWT Directwind 54	
Height:	50m	
de diameter:	54m	
al height to blade tip:	77m	
bine location:	334397 744313	

is theoretic	cal visibility map is based on a receptor viewing height		
1.8m AGL.	The levels of theoretical visibility are based on the fol-		
ving colouring scheme:			
le:	Only the blades are theoretically visible from these		
	areas		
llow:	At least the nacelle and blades are theoretically visible		
	in these areas		
d:	The blades, nacelle and tower down to a point at least		
	1m AGL are theoretically visible in these areas		